



One Golden Beach Drive, Golden Beach, FL 33160



THE MARTIN ARCHITECTURAL GROUP, P.C. **Constructions Documents**

03/28/22











OWNER: Town of Golden Beach ARCHITECT: The Martin Architectural Group STRUCTURAL Master Consulting Engineers, INC. **Civic Building One Golden Beach Drive Suite 185** Golden Beach, FL, 33160 P: (305) 932-0744

6810 Lyons technology Circle, ENGINEER: Cocnut Creek, Florida 33073 P: (954) 428-1618 **Contact: Dominick Ranieri, AIA** Principal e: dranieri@MARTINAIA.com

4101 Ravenswood Rd, Suite 307 Fort Lauderdale, FL, 33312 P: Tampa (813) 287-3600, Ft. Laud. (954) 210-7671 **Contact: Armando Castellon , P.E. Principal**

e: Armando.Castellon@mcengineers.com

MECHANICAL Formica & Associates Consulting Engineering CIVIL ENGINEER: 980 N Federal Highway, #100 Boca Raton, FL, 33432 P: (561) 368-3611 Ext. 103 **Contact: Steve Henderson, P.E. Principal** e: steve.henderson@formicaengineering.com

KEITH ENGINEER: 120 N. Federal Highway, Suite 208 Lake Worth, FL, 33460 O: (561) 469-0992 M: (561) 789-3113 **Contact: Stephen Williams, Sr., P.E.** e: SWilliams@keithteam.com

LANDSCAPE: Andres Montero 2208 NE 26th st., Unit 1 Fort Lauderdale, FL 33305 P: (954) 591-5606 **Contact: Andres E. Montero** e: amontero@amlastudio.com

A0.00

	ARCHITE	ECTURAL SYM	1BOLS	S LIST	
BRICK	STEEL	PLYWOOD: SMALL SCALE		DOOR SYMBOL	SECTION NUMBER
CONCRETE MASONRY UNIT	PLASTER CEMENT, SAND, GROUT	METAL: SMALL SCALE STRUCTURAL, FLASHING		WINDOW SYMBOL	UA-3 SHEET NUMBER
CAST IN PLACE OR PRE-CAS	ROCK OR STONE	GYPSUM WALL BOARD	2	REVISION NUMBER	BUILDING SECTION
LIGHT WEIGHT CONCRETE	CRUSHED STONE, GRAVEL OR POROUS FILL	STUCCO REINFORCED	VOID 32	ELEVATION NO. INTERIOR ELEVATION	
CAST STONE	CUT STONE, BLUESTONE, FLAGSTONE OR SLATE	RESILIANT FLOORING	₩1 UA-3 	——SHEET NO.	SECTION NUMBER
EARTH: UNDISTURBED	STONE: ROUGH-CUT OR RUBBLE	CARPET AND PAD	СРТ. С.Т.	. CHANGE OF FLOOR FINISH	D-2 SHEET NUMBER DETAIL
EARTH: BACKFILL	WOOD: FINISH	CERAMIC TILE: LARGE SCALE	—	DATUM ELEVATION	22./,42
BATT OR BLOWN INSULATION	ON WOOD: ROUGH	CERAMIC TILE: PROFILE		MATCH LINE	SECTION NUMBER
RIGID INSULATION	WOOD BLOCKING	GLASS: LARGE SCALE	•	(TB) TEST BORING (WP) WORK POINT (DP) DATUM POINT (CP) CONTROL POINT	D-2_SHEET NO.
METAL, ALUMINUM, ECT.	PLYWOOD: LARGE SCALE	GLASS: SMALL SCALE	1	WALL PARTITION TYPE	DETAIL ENLARGEMENT

ASST ASSEMBLE FIC FIRE HOSE ASSEMBLY FIL FIRE PROOF FIREPROOF SELF-CLOSING BB BULLETIN BOARD BC STIREPROOF SELF-CLOSING BK SH BB.O. BC BUILDING CODE / BROOM CL. BK SH BOOK SHELVES FOR BRACKET GB CALVANIZED NOT COMPLETING BRACKET GB CALVANIZED NIC COURSE? CHANNEL GB CALVANIZED NIC CENTERLINE C GG GRADE G	
ASST ASSEMBLE FHC FIRE HOSE ASSEMBLY FL LOOK / FIREPROF FIREPLACE WILLDING CODE / BROOK SHELVES FPSC BLULETING GODE / BROOK SHELVES FRSC BLULETING GODE / BROOK SHELVES FRSC BLULETING GODE / BROOK SHELVES FRSC BLUCK BB.O. BOTTOM OF BRC BRC BRKT BRICK GBRKT GODE / BRC	ERATOR
ACST ACOUSTIC EXP EXPANSION LD LEADER DRAIN REQD REQUIR ACTUAL ACTUAL FA FA CUISTICAL CEILING TILE / FA FACTUAL FA FA FIRE ALARM LGTH LANDING REQS REQUIR RACTUAL FA FA FIRE ALARM LGTH LENGTH ROLL FAR FOLL FOR DRAIN LANDING REQS REQUIR REQUIR REGISTRATION LDD LANDING REQS REQUIR REGISTRATE FOR THE BRICK LT LIGHT (PANE OF GLASS) SA SOUND REPORT OF GLASS AND SA SOUND MAX MAXIMUM SDG SIDING APP APPROVED FE FIRE PISTINGUISHER MC MEDICINE CABINET SF SQUARE ASPH ASPHALT FH FIRE HOSE MECH MECH MECHANICAL SH SHELVE ASSEM ASSEMBLE FHC FIRE HOSE CABINET MFG MANUFACTURING SHITHG HUNG SSY ASSEMBLY FIRE FIRE HOSE MECH MECHANICAL SH SHELVE BB BULLETIN BOARD FP FIRE FIRE FIRE FIRE FIRE FIRE HOSE MIR MIRROR ST ST STAINLE BC BUILDING CODE / BROOM CL. FPR FIREPROOF SELF-CLOSING MOREOUS BLKG BLOCK / BLACK FR FROM FRAMING N/A NOT APPLICABLE SUPSO STORY BLKG BLOCK / BLACK FR FROM FRAMING N/A NOT APPLICABLE SUPSO STORY BRK BRICK GB BACKING GALVANIZED NIC NON COMBUSTIBLE CLG SUSPEN BRK BRACKET GC GENERAL CONTRACTOR OA OVERALL TB TOWEL CC COURSE / CHANNEL GL GL GLASS BLOCK OCC COUPANCY THE THE THE FIRE FIRE FIRE FIRE FIRE FIRE FIRE FIR	
ACT ACOUSTICAL CEILING TILE / EXT	
ACTUAL ADH	
ADH ADHESIVE	
AFF	ATTENTUATION
AGGR AGGREGATE	
APP ACCESS PANEL FDN FOUNDATION MAX MAXIMUM SDG SIDING ASPH ALT FH FIRE HOSE FH FIRE HOSE CABINET MFG MANUFACTURING SHTHIG HUNG ASSEMBLE FHC FIRE HOSE CABINET MFG MANUFACTURING SHTHIG HUNG ASSEMBLE FHC FIRE HOSE CABINET MFG MANUFACTURING SHTHIG HUNG ASSEMBLE FHC FIRE HOSE CABINET MFG MANUFACTURING SHTHIG HUNG ASSEMBLE FHC FIRE HOSE CABINET MFG MANUFACTURING SHTHIG HUNG ASSEMBLE FHC FIRE HOSE CABINET MFG MANUFACTURING SHTHIG HUNG STC STAINLING MFR MIRROR ST STAINLING MFR MIRROR STC STAIR / MRB MOLDING STC STAIR / STAINLING MRB MOLDING STC STAIR / SOUND STORY SOUND MRB MOISTURE RESISTANT BOARD SUPSD STORY SOUND SUPSD STORY SUPSD STORY SOUND SUPSD STORY SUPSD SUPSD STORY SUPSD STORY SUPSD SUPSD STORY SUP	DETECTOR
APP APPROVED FE FIRE EXTINGUISHER FIRE MOSE MECHANICAL SH SHELVE FIRE HOSE CABINET MECHANICAL SH SHELVE FIRE HOSE CABINET MECH MECHANICAL SH SHELVE SH SHELVE SH SHELVE SH SHELVE SH SHELVES SHULLETIN BOARD ST. STAINLING MER MANUFACTURER SS SHEATH SEARCH ST. STAINLING MIR MIRROR ST. STAINLING MOLDING ST. STAINLING MOLDING ST. STAINLING MOLDING ST. STAINLING MOLDING ST. STAINLING ST. STAINLING MOLDING ST. STAINLING NO. NON COMBUSTIBLE CLG SUSPEN SUPERS STORY SOUND SUPERS SUPERS STORY SOUND SUPERS SUPERS STORY SOUND SUPERS SUPERS SOUND SUPERS STORY SUPERS S	
ASPH ASSEM BLY ASSEMBLY BB BULLETIN BOARD BC FPSC FIREPROOF FRERPOOF FRERPOOF FRERPOOF FRAMING BLKG BLCK BLOCK JBLACK BLCK BLKG BLCK BLCK BRACKING BRACING BRACING BRACING BRACING BRACING BRACKET	
ASSEM ASSEMBLE ASSEMBLY ASSEMBLY ASSEMBLY ASSEMBLY ASSEMBLY FL FLOOR / FLASHING MFR MANUFACTURER SS SHEATH BB BULLETIN BOARD FP FIREPLACE MIR MIRROR ST STAINLING MFR MANUFACTURER SS SHEATH MIRROR ST STAINLING MIRROR ST SOUND STORY SOUND MIRROR ST SOUND STORY SOUND MIRROR ST SOUND MIRRO	S / SHOWER / SINGLE
ASSY BB BULLETIN BOARD FF FIREPLACE MIR MIRROR ST STAINLI BLOOK / FLASHING FIREPLACE MIR MIRROR ST STAINLI MIRROR ST STAINLI BLOCK / BLACK FR FRONT MRB MOISTURE RESISTANT BOARD SUPSD STORY BLKG BLOCK / BLACK FR FRONT MRB MOISTURE RESISTANT BOARD SUPSD STORY BLKG BLOCK / BLACK FR FRONT MRB MOISTURE RESISTANT BOARD SUPSD STORY BLKG BLOCK / BLACK FR FRONT MRB MOISTURE RESISTANT BOARD SUPSD STORY N/A NOT APPLICABLE SUSP SUPERS BLOCK BRACING GALV GALVANIZED NIC NOT IN CONTRACT SVC SERVICE OF SER	5 / 5115 WERT / 511161E
BB BULLETIN BOARD BC BUILLDING CODE / BROOM CL. FPRF FIREPROOF BLK BLOCK / BLACK BLK BLOCK / BLACK BLK BLOCK / BLACK BRACING BRCG BRACING BRK BRICK BRK BRICK BRK BRICK BRACKET C COURSE / CHANNEL C C C COURSE / CHANNEL C C C COURSE / C COURSE / C C C C C C C C C C C C C C C C C C	IING
BC BUILDING CODE / BROOM CL. FPRF FIREPROOF FIREPROOF SELF-CLOSING MO MASONRY OPENING STY SOUND STORY BLK BLOCK / BLACK FR FRONT MRB MOISTURE RESISTANT BOARD SUPSD STORY BLKG BLOCKING FRMG FRAMING N/A NOT APPLICABLE SUSP SUPERS SUSP BRCG BRACING GALV GALVANIZED NIC NOT IN CONTRACT SVC SERVICE BRK BRICK GB GRAB BAR NO NUMBER TEL TELEPH CB CATCH BASIN GL GALSS OC OC ON CENTER TEL TELEPH CB CATCH BASIN GL GALSS OC OC OCCUPANCY THK THICKN CHECK GWB GYPSUM WALL BOARD CHANGE CL CENTERLINE / CL CAST STONE HD HAADWARE PLMB CAMPER CAST AND HADW HARDWARE PLMB DOUBLE HUNG DMPR DAMPER HGT/HT HEIGHT PNL PANEL VT VINYL TILD AND AMPER VT VINYL TILD AMPEN AND CURING TILD AMPEN AND CONDENSING VB VAPOR PANEL WAN LARDWOOD PLYWOOD VIF VERIFY ON THE CONTRACT ON TO VINYL TO V	ESS STEEL / SLOP SINK
BK SH BOOK SHELVES FPSC FIREPROOF SELF-CLOSING MO MASONRY OPENING STY SOUND STORY BLK BLOCK / BLACK FR FRONT MRB MOISTURE RESISTANT BOARD SUPSD STORY NOT APPLICABLE SUSP SUPERS SUPERS SUPERS STORY NOT APPLICABLE CLG SUSPEN SUPERS SUSP SUSP SUSP SUSP SUSP SUSP SUSP SU	•
BLK BLOCK / BLACK FR FRONT MRB MOISTURE RESISTANT BOARD SUPSD STORY BLKG BLOCKING FRMG FRAMING N/A NOT APPLICABLE SUSP SUPERS SUPERS BLOCK MORE BRACING GALV GALVANIZED NIC NOT IN CONTRACT SVC SERVICE BRK BRICK GB GRAB BAR NO NUMBER T&& GTONGUL BRK BRACKET GC GENERAL CONTRACTOR OA OVERALL TB TOWEL TELL TELEPH CB CATCH BASIN GL BL GLASS BLOCK OCC OCCUPANCY THK THICKN CHG CHANGE GR GRADE OPG OPENING T.O. TOP OF CHK CHECK GWB GYPSUM WALL BOARD PAR PARAPET / PARALLEL TR TREAD, CL CENTERLINE / CLOSET GYP GYPSUM P/C POURED CONCRETE TYP TYPICAL C/L CENTERLINE HB HOSE BIBB PIL PILASTER UL UNDERN CC CAST STONE HD HEAD P/L PLATE / PLUG / PLACE U.N.O. UNLESS DMPR DAMPER HGT/HT HEIGHT PNL PANEL VT VINYL T	TRANSMISSION CLASS
BLKG BLOCKING FRMG FRAMING N/A NOT APPLICABLE SUSP SUPERS B.O. BOTTOM OF FTG FOOTING NC NON COMBUSTIBLE CLG SUSPEN BRCG BRACING GALV GALVANIZED NIC NOT IN CONTRACT SVC SERVICE SERVICE GENERAL CONTRACTOR OA OVERALL TB TOWEL C COURSE / CHANNEL GL GLASS OC ON CENTER TEL TELEPH CB CATCH BASIN GL GRADE OPG OPENING T.O. TOP OF CHK CHECK GWB GYPSUM WALL BOARD PAR PARAPET / PARALLEL TR TREAD CL CENTERLINE / CLOSET GYP GYPSUM PL PLUSTER UL UNDERS CS CAST STONE HD HARDWARE PLMB PLUMBING VB VAPOR DMPR DAMPER HGT/HT HEIGHT PNL PANEL VT VINYL T	110 110 11001011 02 100
B.O. BOTTOM OF FTG GALV GALVANIZED NIC NON COMBUSTIBLE CLG SUSPEN SPRCG BRACING GALV GALVANIZED NIC NOT IN CONTRACT SVC SERVICE SPRCE GALVANIZED NIC NOT IN CONTRACT SVC SERVICE SPRCE GALVANIZED NIC NOT IN CONTRACT SVC SERVICE SPRCE GALVANIZED NO NUMBER TEMPORAL TO NO NUMBER TEMPORAL TO NO NUMBER TEMPORAL TEM	SEDE
BRCG BRACING BRK BRICK BRK BRICK BRK BRICK BRKT BRACKET GC GENERAL CONTRACTOR C COURSE / CHANNEL C C COURSE / C CO	IDED CEILING
BRK BRICK BRACKET C COURSE / CHANNEL CB CATCH BASIN CHG CHANGE CHK CHECK CL CENTERLINE / CLOSET C/L CENTERLINE CLKG CAST STONE CLKG CAST STONE CD CAST STONE CD CAST STONE CD CATCH BASIN CB CATCH BASIN CB CB CB CATCH BASIN CB	
BRKT BRACKET GC GENERAL CONTRACTOR OA OVERALL TB TOWEL C COURSE / CHANNEL GL GLASS OC ON CENTER TEL TELEPH CB CATCH BASIN GL BL GLASS BLOCK OCC OCCUPANCY THK THICKN CHG CHANGE GR GRADE OPG OPENING T.O. TOP OF CHK CHECK GWB GYPSUM WALL BOARD PAR PARAPET / PARALLEL TR TREAD CL CENTERLINE / CLOSET GYP GYPSUM P/C POURED CONCRETE TYP TYPICAL C/L CENTERLINE HB HOSE BIBB PIL PILASTER UL UNDERVICE CS CAST STONE HC HANDICAPPED PL PLATE / PLUG / PLACE U.N.O. UNLESS CS CAST STONE HD HEAD P/L PLASTIC LAMINATE VAN VANITY D DRYER / DRAIN HDW HARDWARE PLMB PLUMBING VB VAPOR DH DOUBLE HUNG HOWD HARDWOOD PLYWD PLYWOOD VIF VERIFY DMPR DAMPER HGT/HT HEIGHT PNL PANEL VT VINYL T	E & GROOVE
C COURSE / CHANNEL GL GLASS OC ON CENTER TEL TELEPH CB CATCH BASIN CHG CHANGE CHANGE CHANGE CHK CHECK CL CENTERLINE / CLOSET C/L CENTERLINE CLKG CAULKING CHC CAUCHING CHC CHC CHC CAUCHING CHC CHC CHC CHC CHC CHC CHC CHC CHC CH	
CB CATCH BASIN CHG CHANGE CHK CHECK CL CENTERLINE / CLOSET CLKG CAULKING CLKG CAULKING CS CAST STONE CD DRYER / DRAIN CD DRYER / DRAIN CH CB CHANGE CH CHECK	
CHG CHANGE CHK CHECK CHECK CL CENTERLINE / CLOSET CLKG CAULKING CS CAST STONE DH DOUBLE HUNG DH DOUBLE HUNG DMPR CHK CHECK CHECK GWB GYPSUM WALL BOARD GYP GYPSUM CYP CYPSUM CYP	
CHK CHECK CH	
CL CENTERLINE / CLOSET GYP GYPSUM P/C POURED CONCRETE TYP TYPICAL CLKG CAULKING HB HOSE BIBB PIL PILASTER UL UNDERN CLKG CAULKING HC HANDICAPPED PL PLATE / PLUG / PLACE U.N.O. UNLESS CAST STONE HD HEAD P/L PLASTIC LAMINATE VAN VANITY D DRYER / DRAIN HDW HARDWARE PLMB PLUMBING VB VAPOR DH DOUBLE HUNG HDWD HARDWOOD PLYWD PLYWOOD VIF VERIFY DAMPER HGT/HT HEIGHT PNL PANEL VT VINYL T	/ TRASH ROOM
C/L CENTERLINE HB HOSE BIBB PIL PILASTER UL UNDERVICES CAULKING HC HANDICAPPED PL PLATE / PLUG / PLACE U.N.O. UNLESS CAST STONE HD HEAD P/L PLASTIC LAMINATE VAN VANITY D DRYER / DRAIN HDW HARDWARE PLMB PLUMBING VB VAPOR DH DOUBLE HUNG HDWD HARDWOOD PLYWD PLYWOOD VIF VERIFY DMPR DAMPER HGT/HT HEIGHT PNL PANEL VT VINYL T	•
CLKG CAULKING HC HANDICAPPED PL PLATE / PLUG / PLACE U.N.O. UNLESS CS CAST STONE HD HEAD P/L PLASTIC LAMINATE VAN VANITY D DRYER / DRAIN HDW HARDWARE PLMB PLUMBING VB VAPOR DAMPER HGT/HT HEIGHT PNL PANEL VT VINYL T	URITERS LABORATORIES
CS CAST STONE HD HEAD P/L PLASTIC LAMINATE VAN VANITY D DRYER / DRAIN HDW HARDWARE PLMBING VB VAPOR DH DOUBLE HUNG HDWD HARDWOOD PLYWD PLYWOOD VIF VERIFY DMPR DAMPER HGT/HT HEIGHT PNL PANEL VT VINYL T	NOTED OTHERWISE
D DRYER / DRAIN DH DOUBLE HUNG DMPR DAMPER HDW HARDWARE HDWD HARDWOOD HGT/HT HEIGHT PLMB PLUMBING PLYWOOD PLYWOOD PLYWOOD PANEL VB VAPOR PLYWOOD VIF VERIFY PANEL VT VINYL T	
DH DOUBLE HUNG HDWD HARDWOOD PLYWD PLYWOOD VIF VERIFY DAMPER HGT/HT HEIGHT PNL PANEL VT VINYL T	
DMPR DAMPER	
DN DOWN HWH HOT WATER HEATER PT PRESSURE TREATED / POINT W WASHE	R / WATER
	CLOSET
DR DRAIN / DOOR INTERIOR DIAMETER QTY QUANTITY WD WOOD	CLOSE
DS DOWNSPOUT INC INCLUDED R RISER / ROUND / RIGHT / RANGE WDW WINDOW	W
DW DISHWASHER INSUL INSULATION R & S ROD & SHELF W GL WIRE G	
	HEATER / WEEP HOLE
	N CLOSET
ELEV ELEVATION / ELEVATOR JT JOINT RD ROOF DRAIN / ROUND WP WATERI	
WT WEIGHT	

CODE SUMMARY GENERAL REQUIREMENTS BUILDING CATEGORY: IV @ BUNKER AND SUPERSTRUCTURE, II @ THE REST OF BUILDING WIND FACTOR: 1.0 @ BUNKER AND SUPERSTRUCTURE, 1.15 @ THE REST OF BUILDING CONSTRUCTION TYPE : TYPE II-B - SPRINKLERED OCCUPANCY GROUP : BUSINESS "B" ULTIMATE WIND VELOCITY, Vult=169 MILES PER HOUR (3-SECOND WIND GUST) EXT. SURFACE COMPONENTS & CLADDING MATERIAL NOMINAL WIND VELOCITY, V ASD = 131 MILES PER HOUR (1-MINUTES SUSTAINED WIND) ULTIMATE WIND VELOCITY, VULT=186 MILES PER HOUR (3-SECOND WIND GUST) BUNKER & SUPERSTRUCTURE NOMINAL WIND VELOCITY, V ASD = 144 MILES PER HOUR (1-MINUTES SUSTAINED WIND) INTERNAL PRESSURE COEFFICIENT, GC pi = ± 0.18 DIRECTIONALITY FACTOR, KD = 0.85 (TYPICAL UNLESS OTHERWISE NOTED) HAZARD CLASSIFICATION: ORDINARY HAZARD WIND-BORNE DEBRIS: BUILDING IS IN A WIND-BORNE DEBRIS ZONE THE STRUCTURAL DESIGN WAS AS PER RATIONAL ANALYSIS. THE DRAWINGS HAVE BEEN STRUCTURALLY DESIGNED TO MEET REQUIREMENTS OF ASCE 7-10 & ACI 530. (SEE STRUCTURAL ENGINEER DESIGN CRITERIA-D2 SHT. S101) EXPOSURE CATEGORY "D"

CODE SUMMARY

CITY OF GOLDEN BEACH, FLORIDA

FLORIDA BUILDING CODE 2017 6TH EDITION
FLORIDA ACCESSIBILITY 2017 6TH EDITION CODE

FLORIDA ACCESSIBILITY 2017 6TH EDITION CODE

FLORIDA BUILDING CODE - PLUMBING 2017 6TH EDITION CODE

FLORIDA BUILDING CODE - MECHANICAL 2017 6TH EDITION CODE

FLORIDA FIRE PREVENTION CODE 2017 6TH EDITION

NFPA LIFE SAFETY CODE 6TH EDITION

APPLICABLE BUILDING CODES

NATIONAL ELECTRICAL CODE 2014 EDITION
FLORIDA ENERGY CONSERVATION 2017 6TH EDITION CODE

APPENDIX G - GUIDANCE FOR IMPLEMENTATION OF PUBLIC SHELTER DESIGN CRITERIA

II. ANALYSIS OF 2017 FBC

CODE SECTION APPLICATION

CHAPTER 3

USE GROUP:

A3 ASSEMBLY (COMMUNITY HALL)

B BUSINESS (CIVIC ADMINISTRATION)

OCCUPANT LOAD: see lifesafety sheet A1.01 & A1.01A

CHAPTER 4, GENERAL BLDG HEIGHTS & AREAS:
406.5 OPEN GARAGE: no exterior wall, defined by ceiling above

CHAPTER 5, GENERAL BLDG HEIGHTS & AREAS:

HEIGHT & AREA ALLOWANCE FOR THE CLUB HOUSE:

MAX. ALLOWANCE:

B: 4 stories, 75ft & 69,000 sq.ft. w/ sprinkler

A-3: 3 stories, 75ft & 28,500 sq.ft. w/ sprinkler

S-2: 4 stories, 75ft & 78,000 sq.ft. w/ sprinkler

ACTUAL PROVIDED: 3 stories, 45'-0" to roof and 25,412 sq.ft.

MIXED USE ALLOWABLE BUILDING AREA: Ground floor: 9893/78000<1

Second floor: 9340/69000<1

Third floor: (1413/28500+4766/69000)<1

SEPARATED OCCUPANCIES: with sprinkler A/S=1hour A/S-2=0, B/S-2=1

CHAPTER 6, TYPES OF CONSTRUCTION:

INCIDENTAL USES

TABLE 601 CONSTRUCTION TYPE: II(B) INT./EXT. WALLS

TABLE 601 FIRE RESISTANCE RATING REQ. FOR BLDG ELEMENTS:

BUILDING ELEMENT REQ'D RATINGS

STRUCTURAL FRAME 0-HR.

BEARING WALLS - INT. & EXT. 0-HR.

NON-BEARING WALLS - EXT. & INT. 0-HR.

FLOOR CONSTRUCTION 0-HR.
ROOF CONSTRUCTION 0-HR.

CHAPTER 7
712.1.9 TWO-STORY OPENINGS: stair #3
713.4 SHAFT FIRE RATING: 1 hour fire barrier

CHAPTER 9, FIRE PROTECTION SYSTEMS

SPRINKLERS PROVIDED PER CODE
FIRE ALARM PROVIDED PER CODE

<u>CHAPTER 10</u> 1005.3.1

TABLE 509

STAIRWAYS: 0.3" per occupancy
OTHER EGRESS COMPONENTS: 0.2" per occupancy

1005.3.2 OTHER EGRESS COMPONENTS: 0.2" per occupancy
TABLE 1006.3.1 ROOF CONSMIN. NUMBER OF EXITS: 2 exits (94 occ<500 occ, see lifesafety sheets)

1016.2.1 MULTIPLE TENANTS ACCESS TO STAIRS W/O PASSING THROUGH EACH OTHER.
TABLE 1017.2 EXIT ACCESS TRAVEL DISTANCE: with sprinkler, A: 250'-0", B: 300'-0", S-2: 400'-0"

TABLE 1020.1 CORRIDOR FIRE RATING: 0 hour with sprinkler

TABLE 1020.2 CORRIDOR MIN. WIDTH: 44"

1020.4 DEAD END: with sprinkler A-3=20', B=50', S=50'

1023.2 INT. EXIT STAIRS: enclosed, 1 hour construction for 3 stories

1028.1 EXP 2 EXIT DISCHARGE: stair #1 egress through vestbule:

XIT DISCHARGE: stair #1 egress through vestbule depth<10', length<30' directly to the outside vestbule is 1 hour rated

III. ANALYSIS OF 2018 STATEWIDE EMERGENCY SHELTER PLAN - APPENDIX G EHPA CRITERIA CODE SECTION APPLICATION

THE BUNKER IS FOR THE USE OF CITY AUTHORIZED PERSONNEL ONLY

G.1 EHPA OCCUPANCY PERIOD: 8 hours min. at max. occupant capacity
G.2.1 WIND LOADS: per ICC 500's design wind speed map
G.2.2 WINDBORNE DEBRIS IMPACT: all ext. surface components and cladding materials

G.2.3 FLOOR SLABS: Require - 2' min. above base flood elevation.
Provide - on 3 floor, 30'-6" above grade

WINDBORNE DEBRIS IMPACT: increased from Level D to Level E LOADS ON BLDG ENVELOPE SAFETY FACTOR: 2.0 min. ROOF COVERINGS: second weather-resistant underlayment

G.2 STRUCTURAL REQUIREMENTS

G.2.5

THE WIND LOAD PERFORMANCE OBJECTIVE OF MODERN BUILDING CODES AND STANDARDS IS TO PREVENT OR REDUCE DEATHS AND INJURIES WITHIN THE BUILT ENVIRONMENT. THIS IS ACHIEVED THROUGH DESIGN AND CONSTRUCTION OF BUILDINGS SUCH THAT, UNDER DESIGN LOADS, PRIMARY LOAD CARRYING SYSTEMS REMAIN STABLE AND DO NOT COLLAPSE. SURVIVAL WITHOUT COLLAPSE IMPLIES THAT OCCUPANTS SHOULD BE ABLE TO FIND AN AREA OF RELATIVE SAFETY INSIDE THE STRUCTURE DURING A SEVERE WIND EVENT. LOCALIZED DAMAGE, BREACH OF THE STRUCTURAL ENVELOPE AND FLOW OF WIND THROUGH THE STRUCTURE AND WATER DAMAGE ARE ACCEPTABLE. HOWEVER, THIS DESIGN PHILOSOPHY IS NOT NECESSARILY ACCEPTABLE FOR PUBLIC HURRICANE EVACUATION SHELTERS (AND CERTAIN OTHER ESSENTIAL FACILITIES).

CODE REVIEW ABOVE IS FOR REFERENCE; REVIEW DOES NOT REPRESENT EVERY CODE PROVISION WHICH THE ARCHITECT HAS DESIGNED FOR.

ARCHITECTS AND OWNERS CONSULTANTS HAVE PROVIDED THEIR OWN COMPREHENSIVE CODE REVIEW FOR THE SYSTEMS WHICH THEY DESIGN.

BUILDING AREA:

Ground floor: 9,893 sf Second floor: 9,340 sf Third floor: 6,179 sf

TOTAL BLDG AREA: 25,412 SQ. FT.

ALL REPORTS, PLANS, SPELIFICAT IONS AND COMPILER FILES RELATING TO THIS PROJECT ARE THE PROPERTY OF THE MARTIN ARCHITECTURAL GROUP. THE MARTIN ARCHITECTURAL GROUP THE MARTIN ARCHITECTURAL GROUP RETAINS ALL COMMON LAW, STATUTE AND OTHER RESERVED RIGHTS INCLUDING THE COPY- RIGHT THERETO. REPRODUCTION OF THE MARTIN ARCHITECTURAL GROUP VIOLATES THE COPYRIGHT LAWS OF THE UNITED STATES AND WILL BE SUBJECT TO LEGAL PROSECUTION.

© 2020, The Martin Architectural Group, P.C.


RCHITECTURAL GROUP, P. IS AND LAND PLANNERS
ROFESSIONAL CORPORATION

PA: JIM RIVIELLO

PM: Annabella Garcia

DRAWN BY: SCH

PROJECT NO: 1931-01

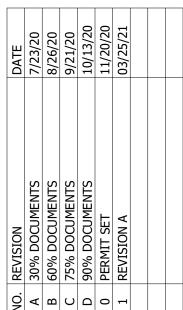

PERMIT SET


GENERAL INFO & CODE

TOWN OF GOLDEN BEACH

CIVIC BUILDING

SCALE: AS NOTED

DATE: 03/25/2021

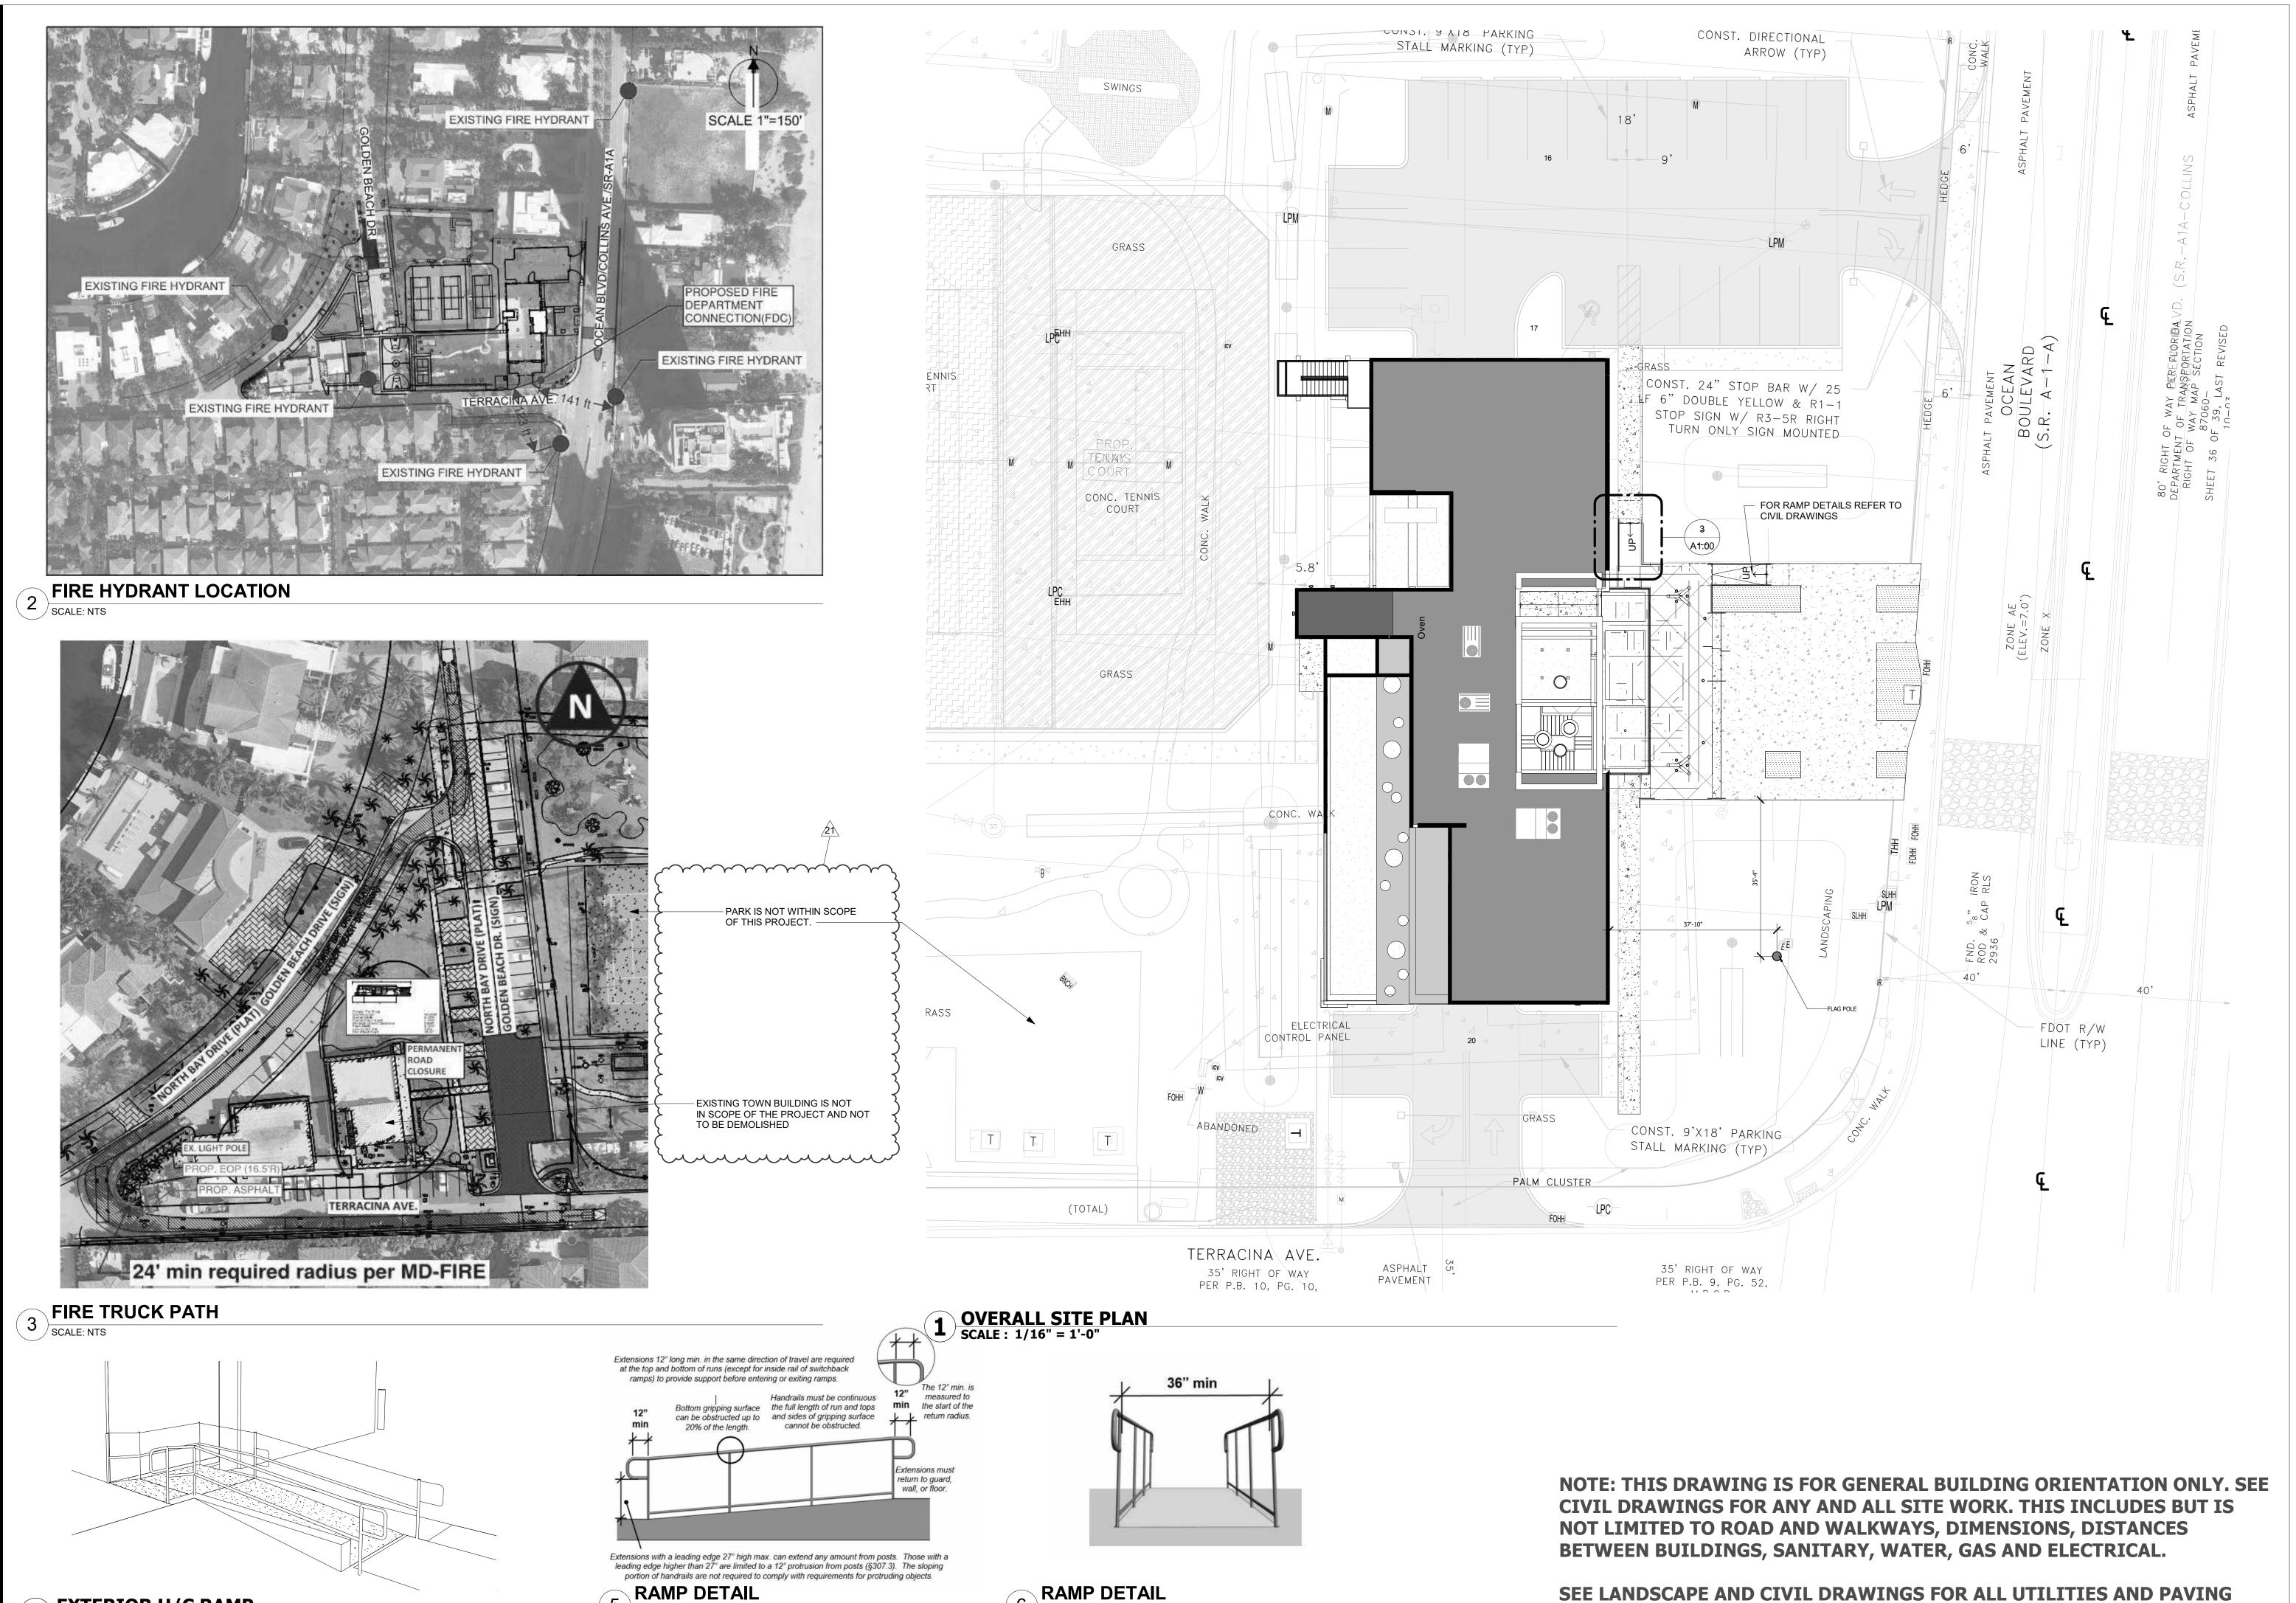

INFORMATION.

EXTERIOR H/C RAMP
SCALE: NTS

ALL REPORTS, PLANS, SPECIFICATIONS AND COMPUTER FILES RELATING TO THIS PROJECT ARE THE PROPERTY OF THE MARTIN ARCHITECTURAL GROUP. THE MARTIN ARCHITECTURAL GROUP RETAINS ALL COMMON LAW, STATUTE AND OTHER RESERVED RIGHTS INCLUDING THE COPY- RIGHT THERETO, REPRODUCTION OF THE MATERIAL HEREIN OR SUBSTANTIAL USE WITHOUT WRITTEN PREMISSION OF THE MASTIN ARCHITECTURAL GROUP VIOLATES THE COPYRIGHT LAWS OF THE UNITED STATES AND WILL BE SUBJECT TO LEGAL PROSECUTION.

© 2020, The Martin Architectural Group, P.C

ARTIN ARCHITECTURAL GROUP, P.
CHITECTS AND LAND PLANNERS
A PROFESSIONAL CORPORATION

PA: JIM RIVIELLO

PM: Annabella Garcia

DRAWN BY: SCH

PROJECT NO: 1931-01

12/57

12/57

12/

 NO.
 REVISION
 DATE

 1
 REVISION A
 03/25/21

 2
 REVISION B
 04/27/21

 3
 REVISION C
 05/07/21

 4
 REVISION D
 05/11/21

 5
 REVISION F
 05/24/21

 6
 REVISION F
 06/28/21

 7
 REVISION G
 12/03/21

 8
 REVISION H
 03/28/22

 21
 Dade County Comments
 04/29/24

PERMIT SET

OVERALL SITE PLAN

TOWN OF GOLDEN BEACH

CIVIC BUILDING


One Golden Beach Drive, Golden Beach, FL 33160

CALE: AS NOTED

03/25/2021

CIVIC BUILDING

A1.00
©) 2020, The Martin Architectural Group, P.C.

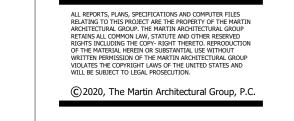


JIM RIVIELLO

Annabella Garcia

DRAWN BY:

PERMIT SET

PROJECT NO:

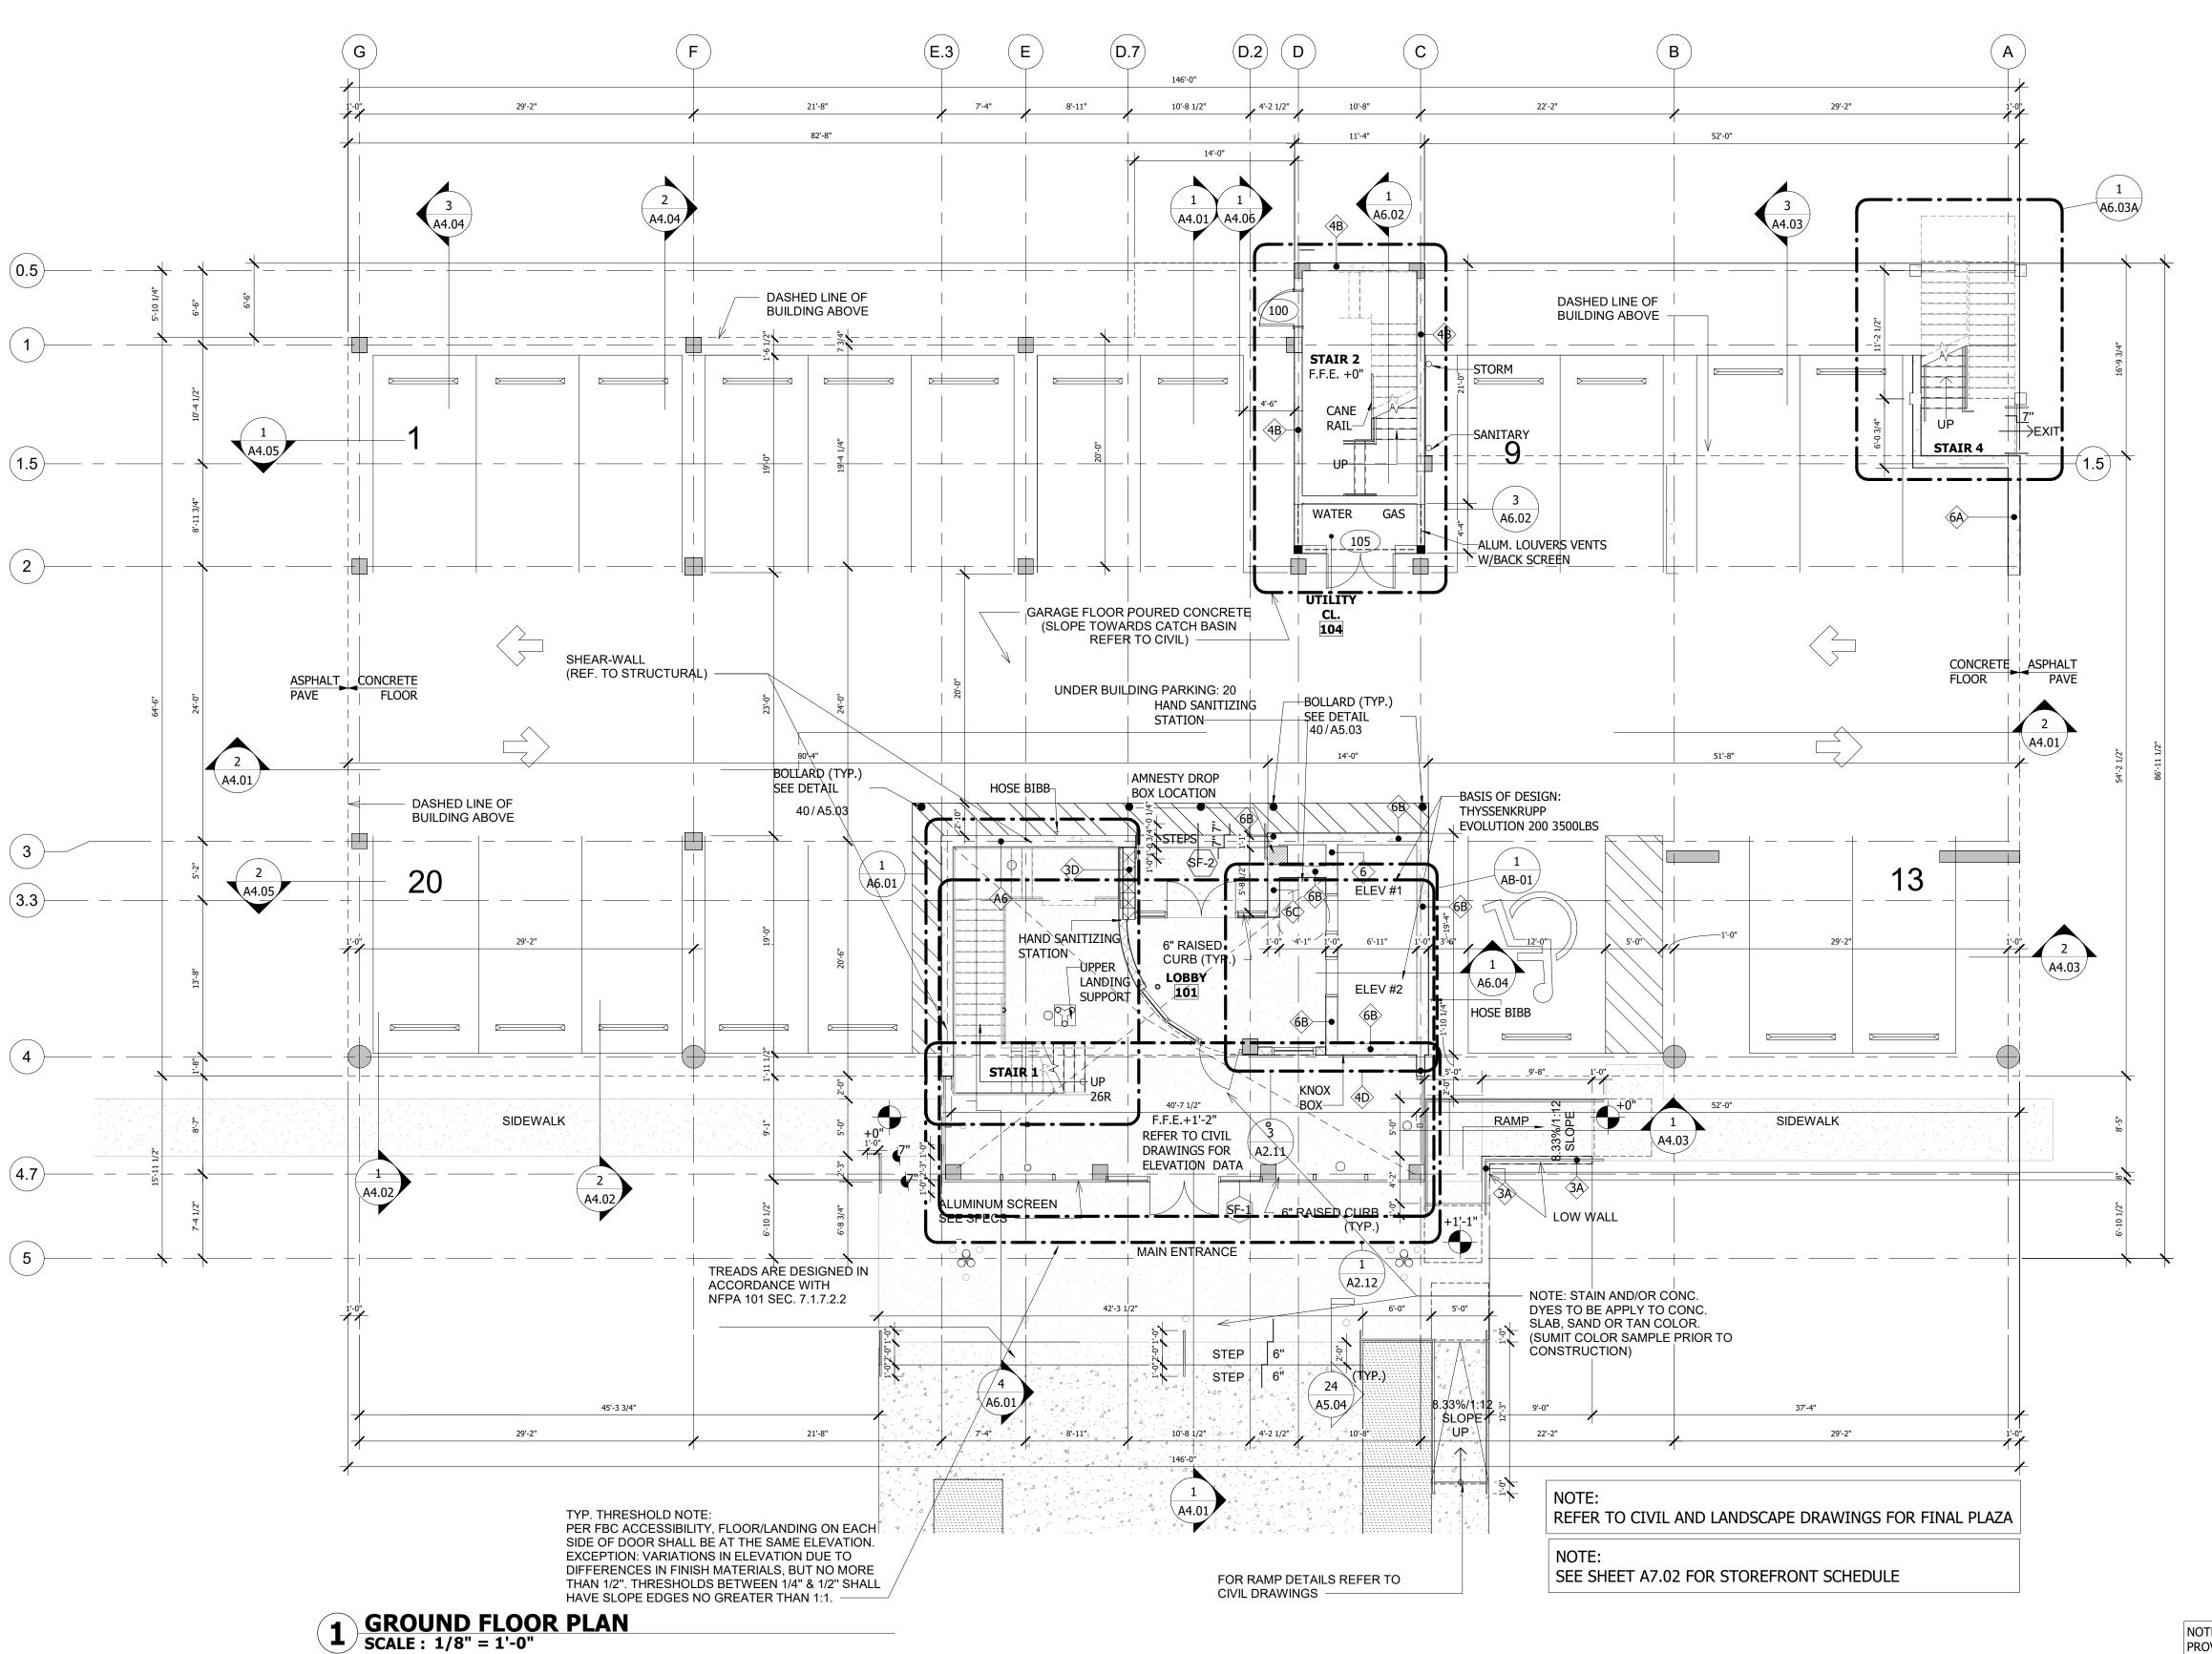

NOTE: SCREEN MANUFACTURER TO PROVIDE NO LESS THAN 50% OPEN AREA IN METAL SCREEN

GENERAL NOTES:

 ALL DIMENSIONS ARE TO ROUGH FRAMING.

 ALL WALLS SHALL BE METAL STUDS UNLESS NOTED OTHERWISE. GAUGE AND SPACING AS PER ENGINEER. ANY LUMBER IN CONTACT WITH MASONRY OR CONCRETE SHALL BE PRESSURE TREATED. ANY EXTERIOR LUMBER SHALL BE PRESSURE TREATED.

 WHERE DRAWINGS ARE IN CONFLICT WITH OTHER DRAWINGS, CONTRACTOR

SHALL NOTIFY THE ARCHITECT.


SCALE: AS NOTED 03/25/2021

GROUND FLOOR PLAN
TOWN OF GOLDEN BEACH

CIVIC BUILDING

© 2020, The Martin Architectural Group, P.C.



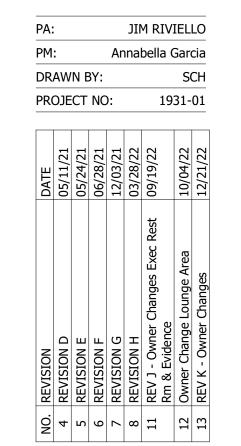

PERMIT SET

SECOND FLOOR PLAN

TOWN OF GOLDEN BEACH

SCALE: AS NOTED 03/25/2021

NOTE: SCREEN MANUFACTURER TO PROVIDE NO LESS THAN 50% OPEN AREA

ALL DIMENSIONS ARE TO ROUGH

ALL WALLS SHALL BE METAL STUDS

ANY EXTERIOR LUMBER SHALL BE

SHALL NOTIFY THE ARCHITECT.

 WHERE DRAWINGS ARE IN CONFLICT WITH OTHER DRAWINGS, CONTRACTOR

SPACING AS PER ENGINEER. ANY LUMBER IN CONTACT WITH MASONRY OR CONCRETE SHALL BE

PRESSURE TREATED.

PRESSURE TREATED.

UNLESS NOTED OTHERWISE. GAUGE AND


IN METAL SCREEN

GENERAL NOTES:

FRAMING.

CIVIC BUILDING

© 2020, The Martin Architectural Group, P.C.

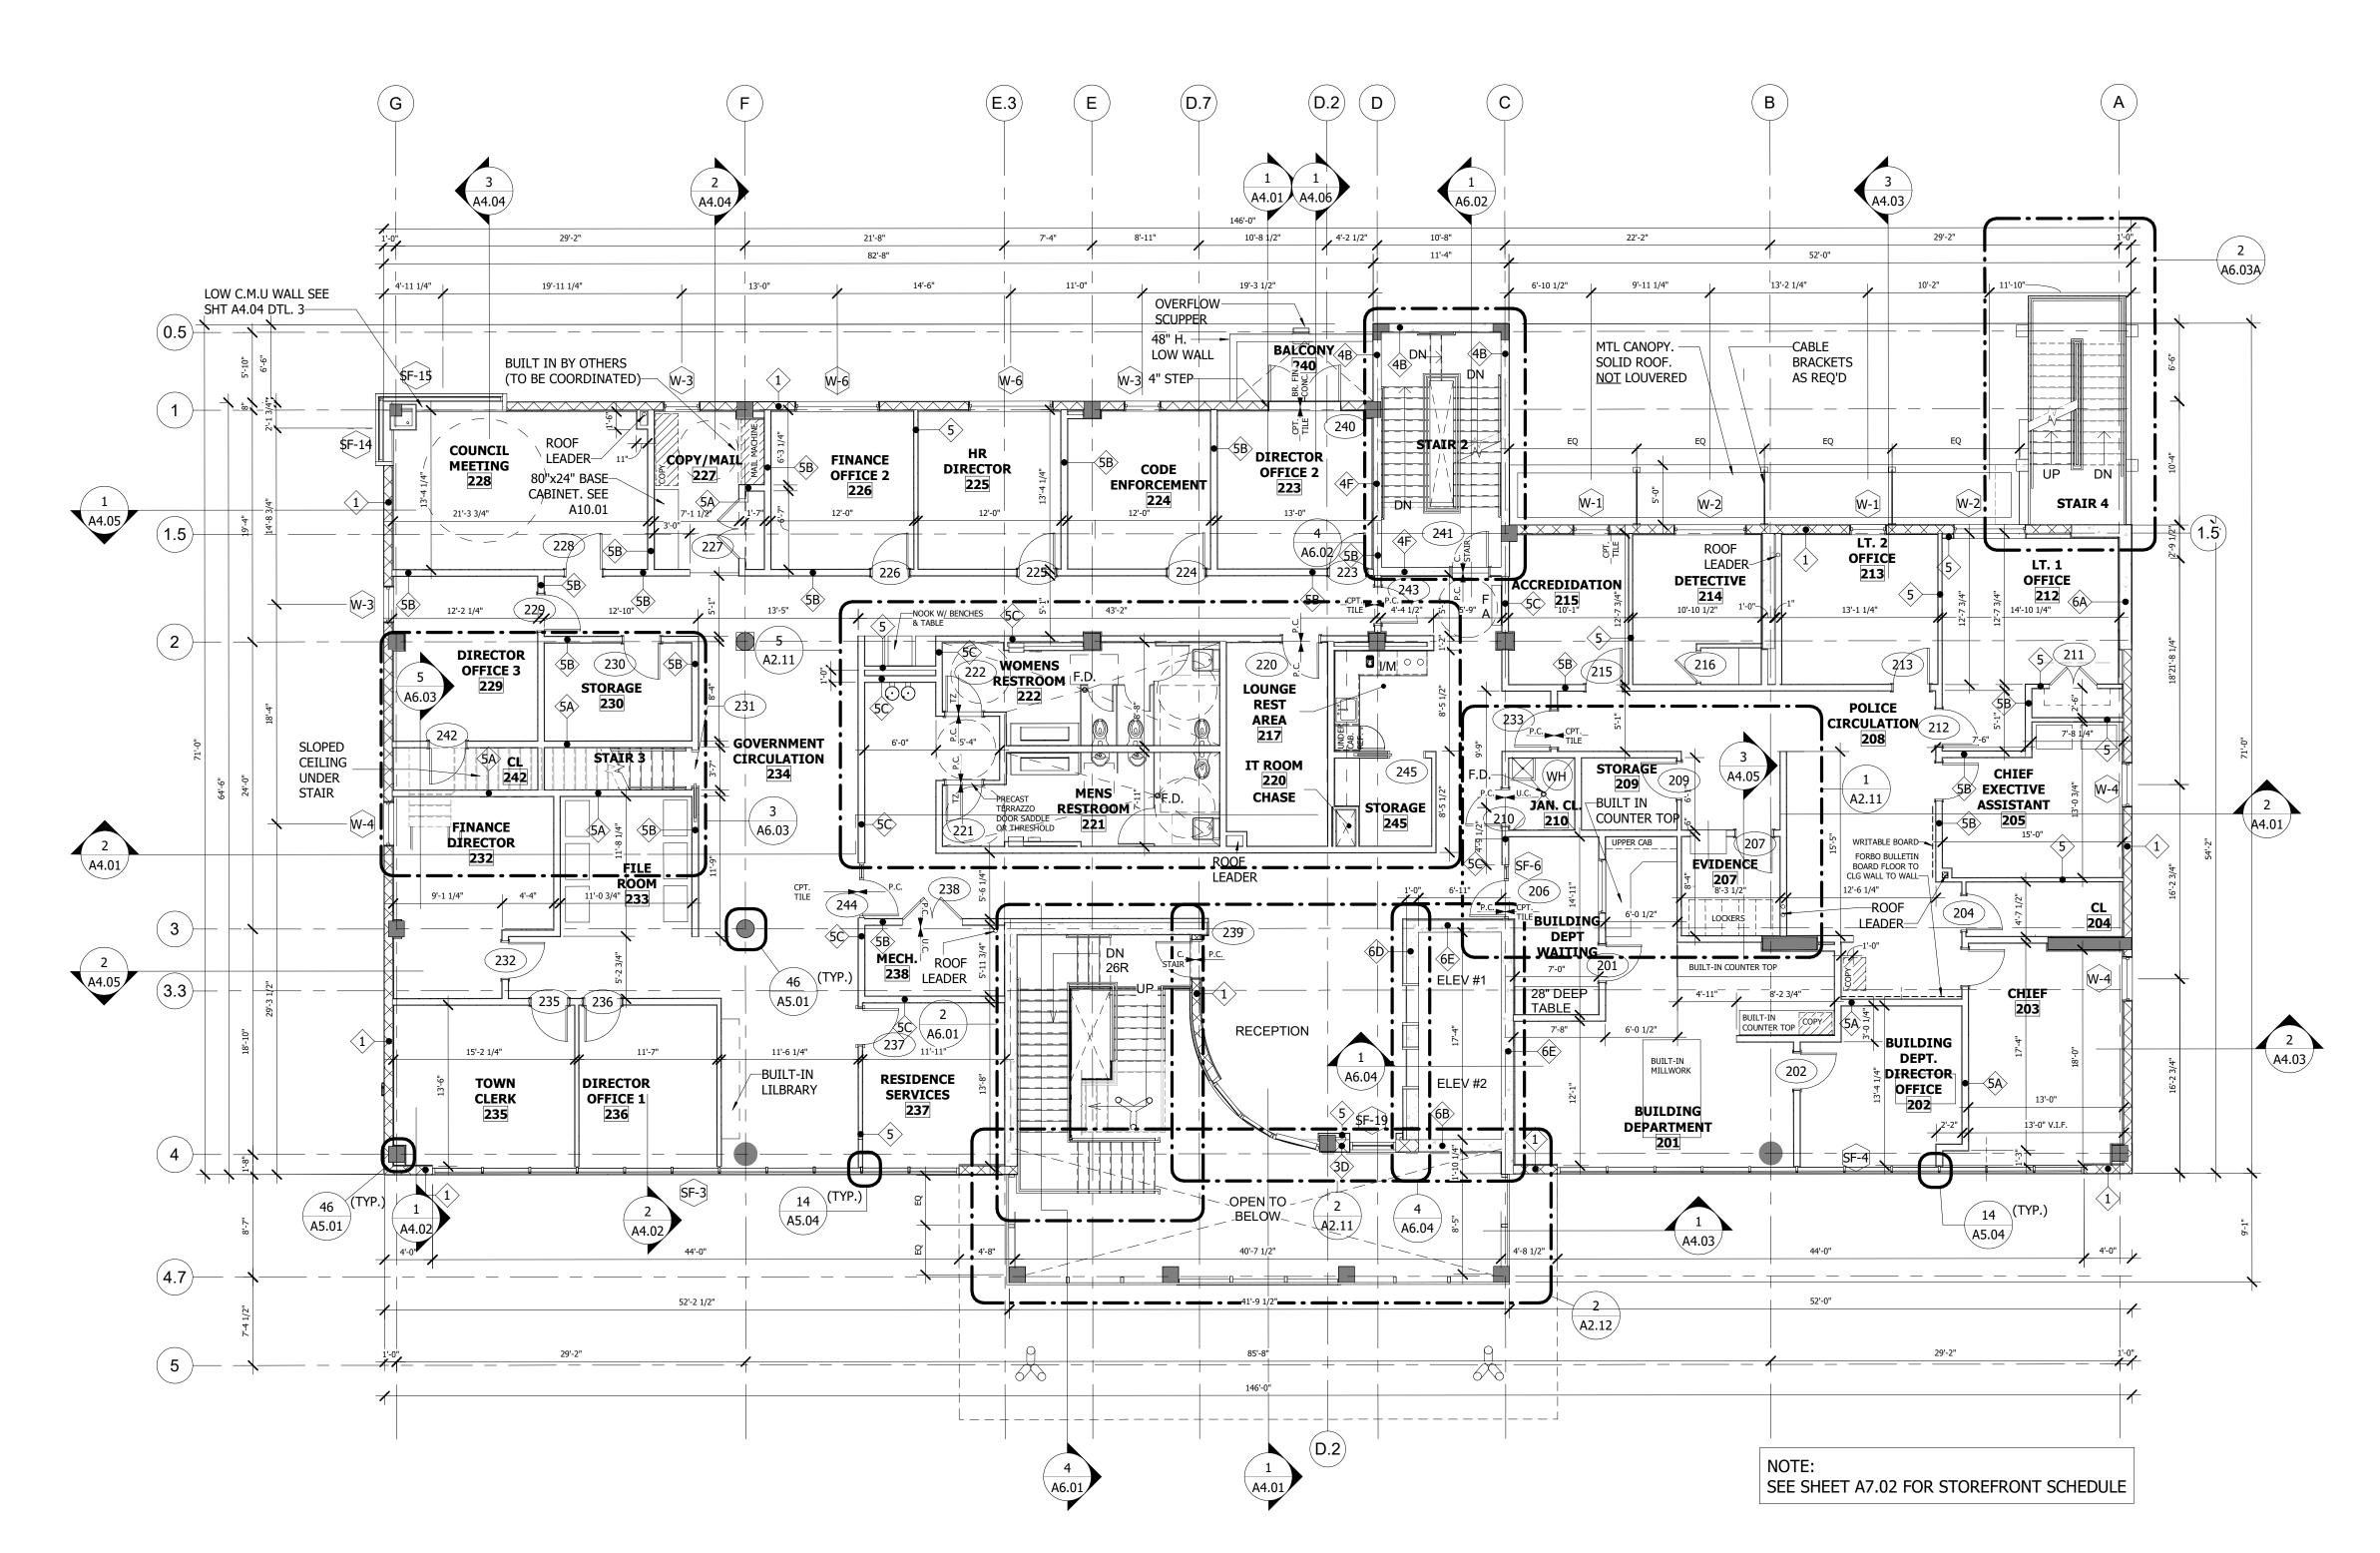

1 2ND FLOOR SCALE: 1/8" = 1'-0"





JIM RIVIELLO

PERMIT SET

THIRD FLOOR PLAN

TOWN OF GOLDEN BEACH

SCALE: AS NOTED 03/25/2021

NOTE: SCREEN MANUFACTURER TO

ALL DIMENSIONS ARE TO ROUGH

ALL WALLS SHALL BE METAL STUDS

ANY EXTERIOR LUMBER SHALL BE

SHALL NOTIFY THE ARCHITECT.

 WHERE DRAWINGS ARE IN CONFLICT WITH OTHER DRAWINGS, CONTRACTOR

SPACING AS PER ENGINEER. ANY LUMBER IN CONTACT WITH MASONRY OR CONCRETE SHALL BE

PRESSURE TREATED.

PRESSURE TREATED.

UNLESS NOTED OTHERWISE. GAUGE AND

IN METAL SCREEN


GENERAL NOTES:

FRAMING.


PROVIDE NO LESS THAN 50% OPEN AREA

CIVIC BUILDING

© 2020, The Martin Architectural Group, P.C.

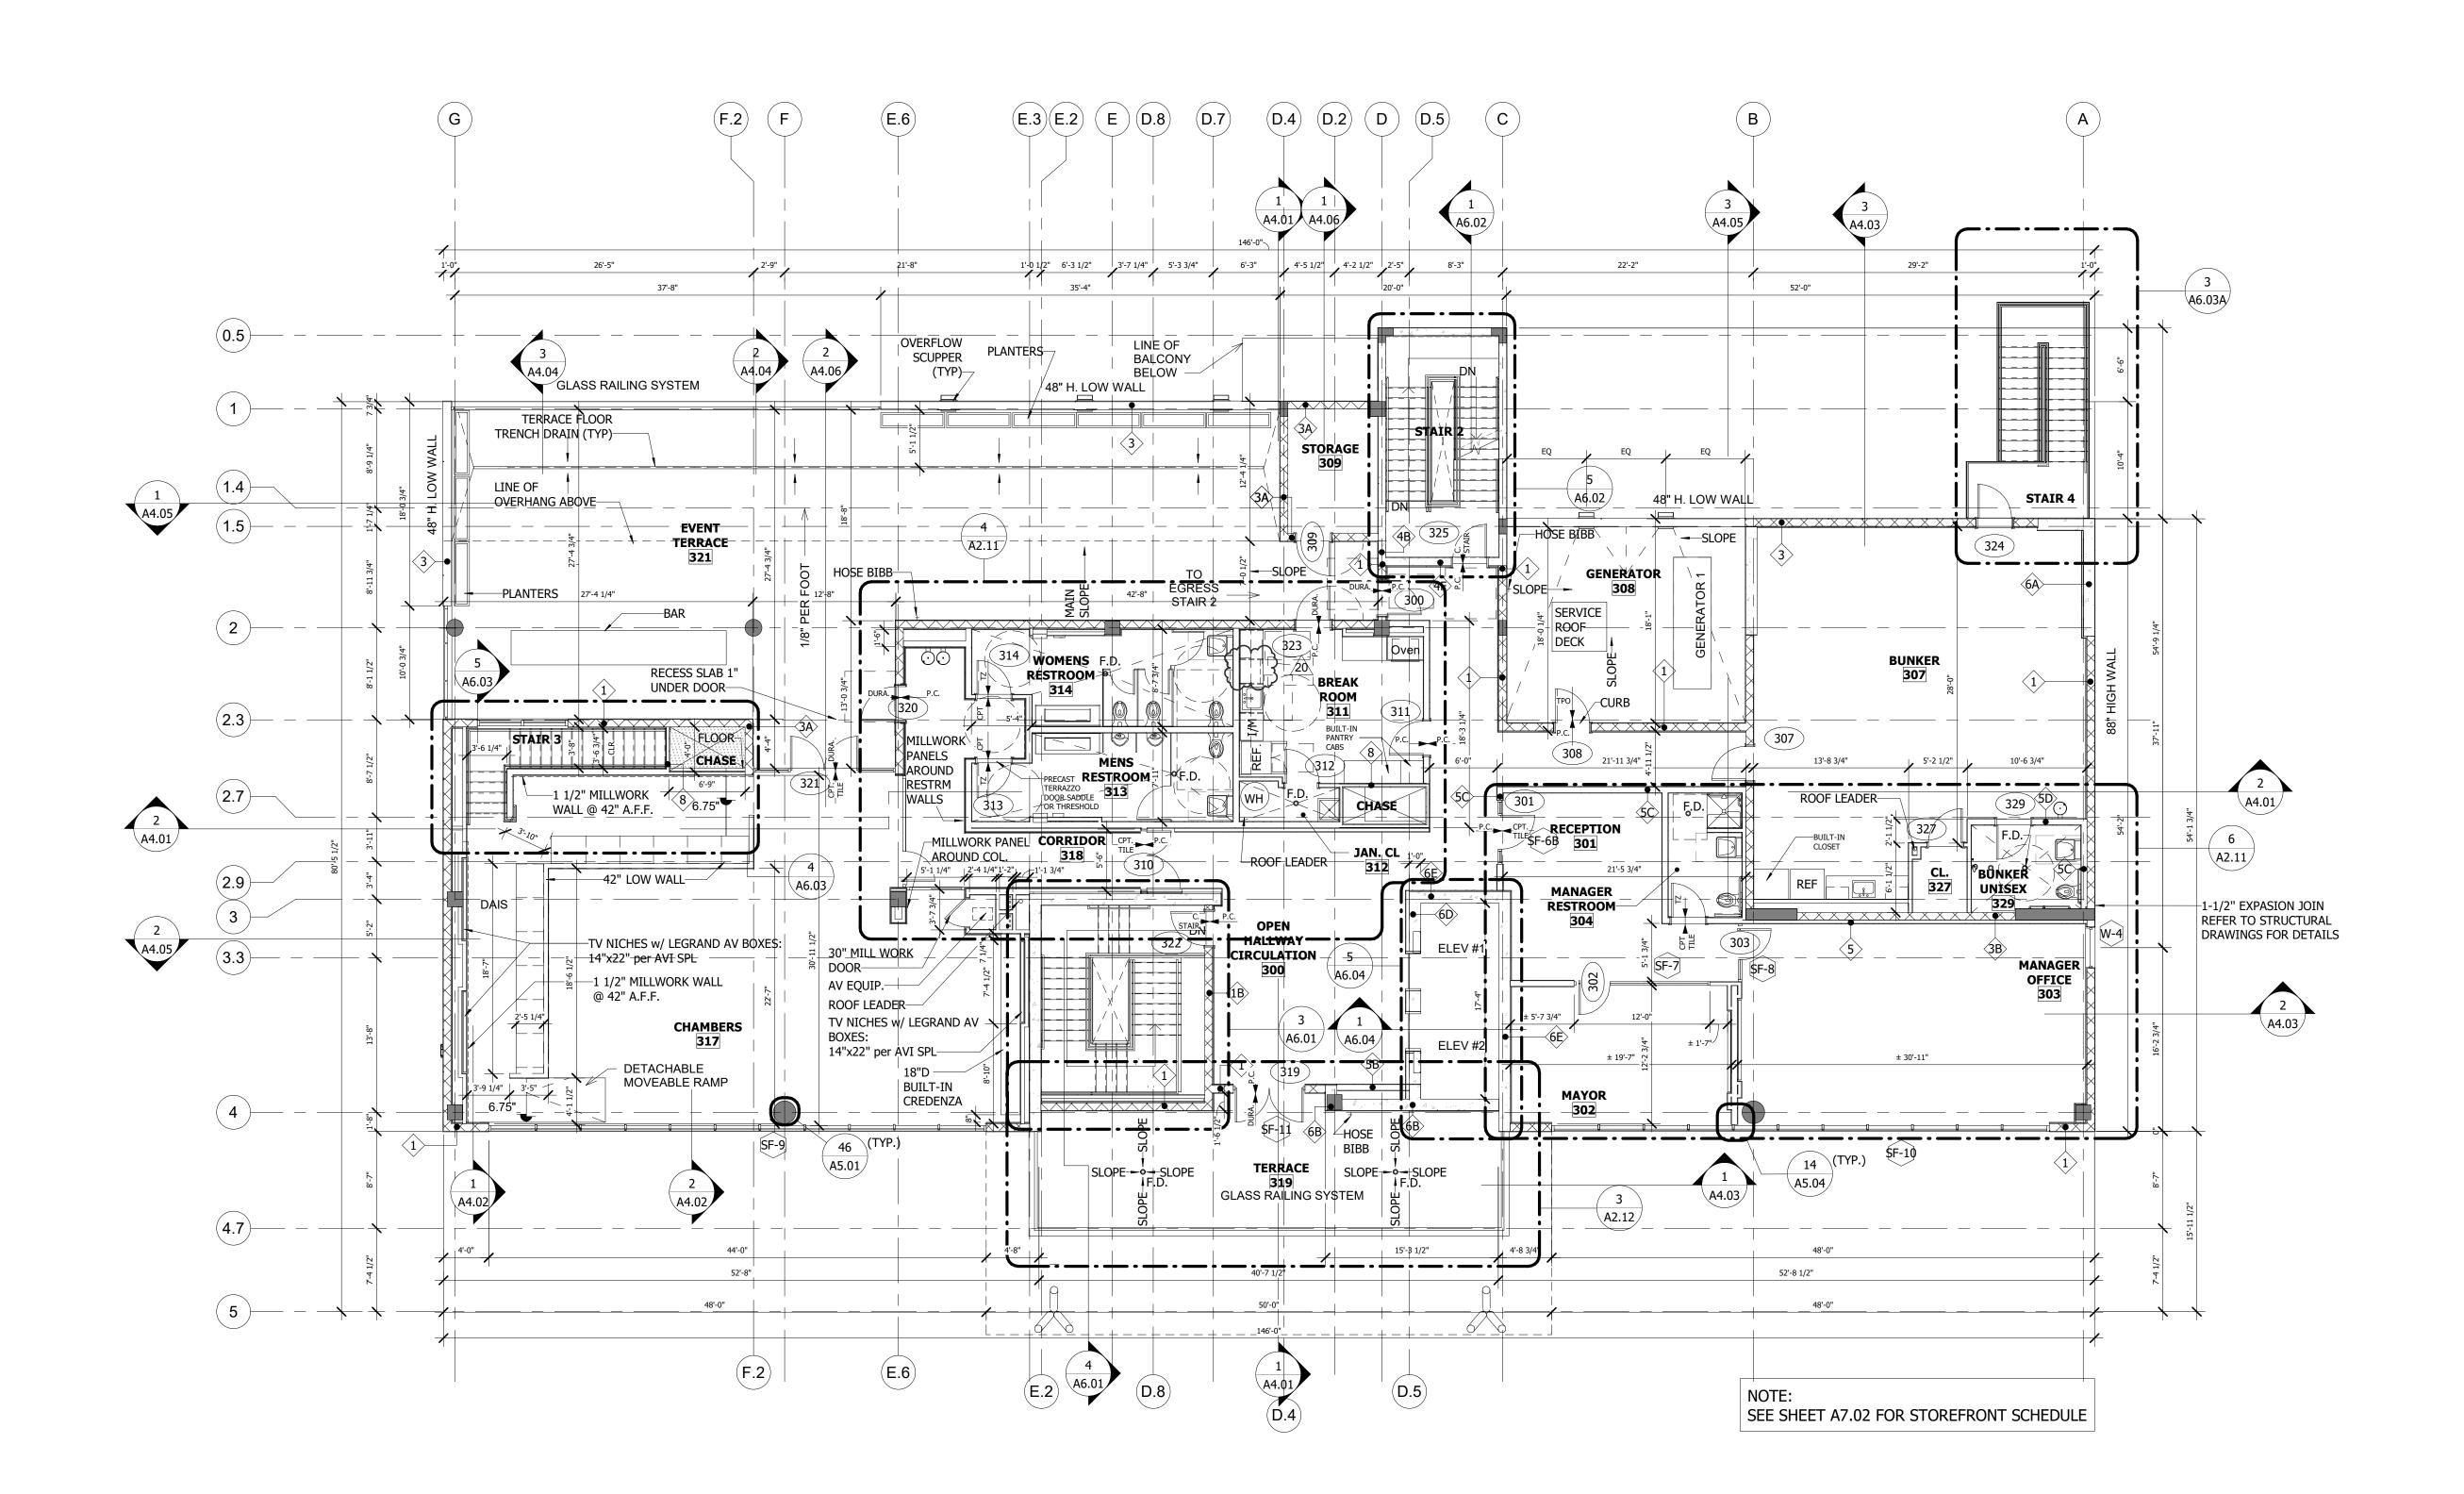

1 3RD FLOOR SCALE: 1/8" = 1'-0"

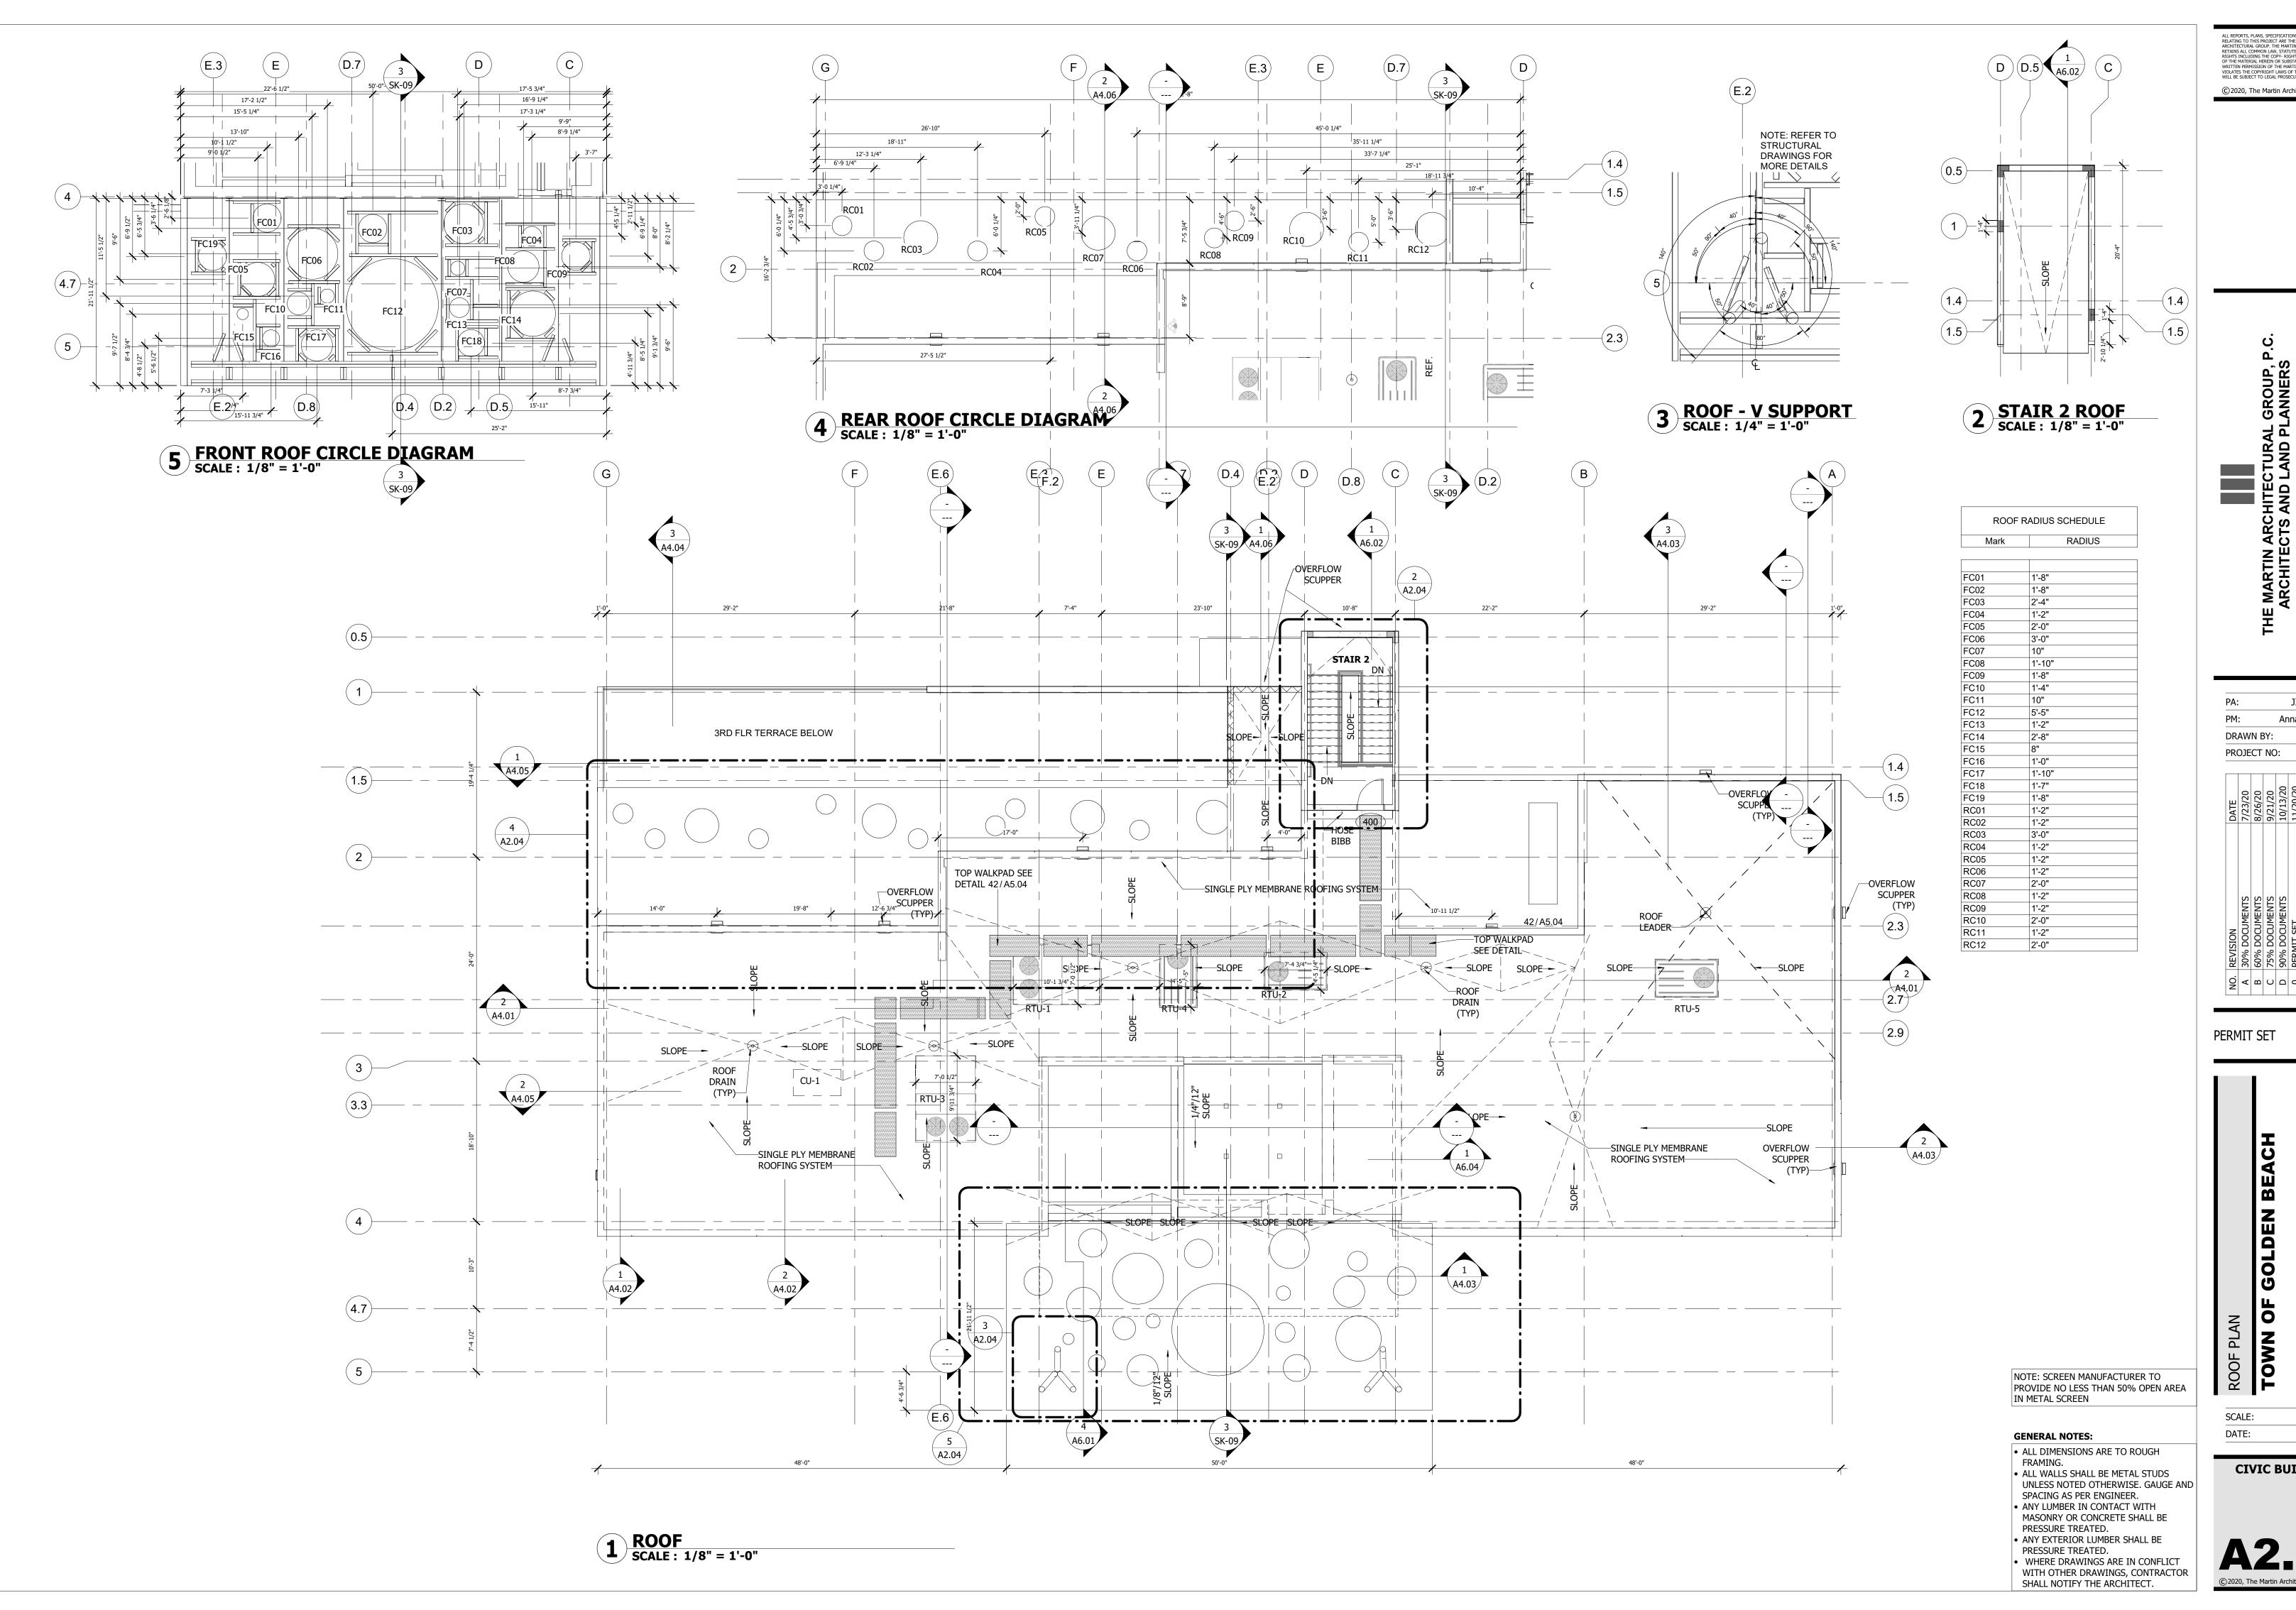

THE MARTIN ARCHITE
ARCHITECTS AND


JIM RIVIELLO Annabella Garcia 1931-01 PROJECT NO:

1 0 D C B A NO.

SCALE: AS NOTED 03/25/2021

CIVIC BUILDING

© 2020, The Martin Architectural Group, P.C.

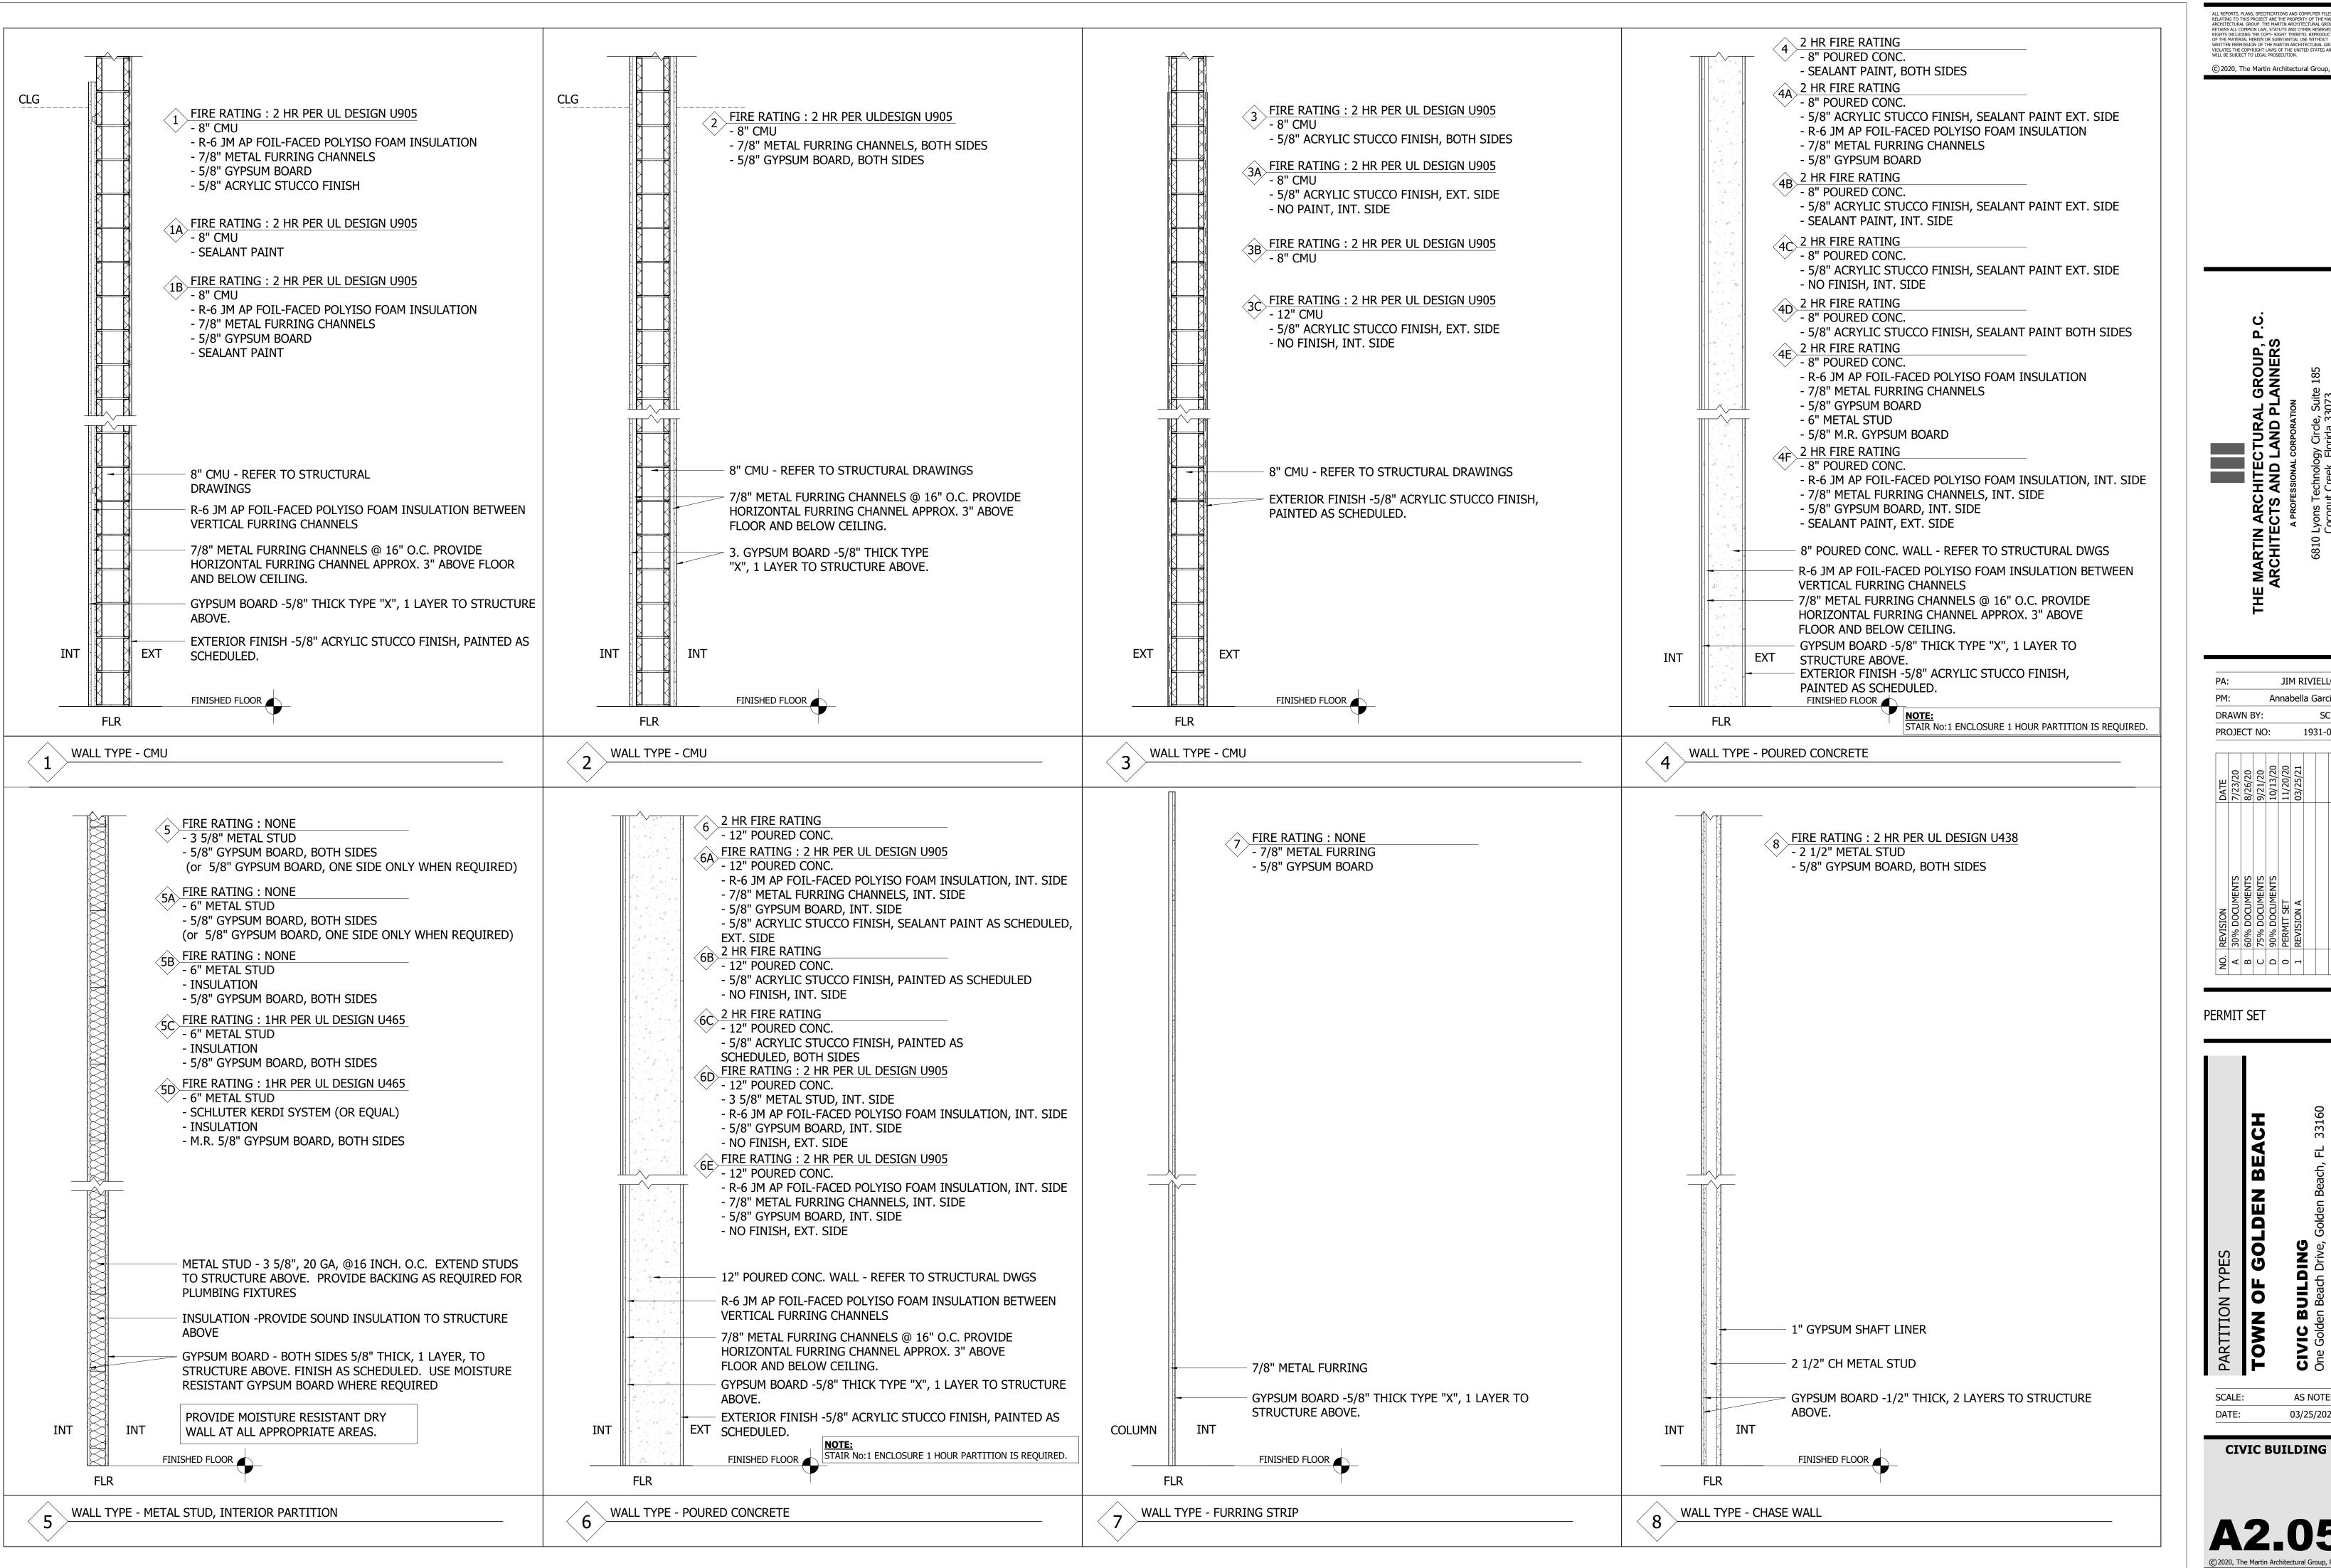

Annabella Garcia PROJECT NO: 1931-01


OF

AS NOTED

03/25/2021

JIM RIVIELLO

© 2020, The Martin Architectural Group, P.C

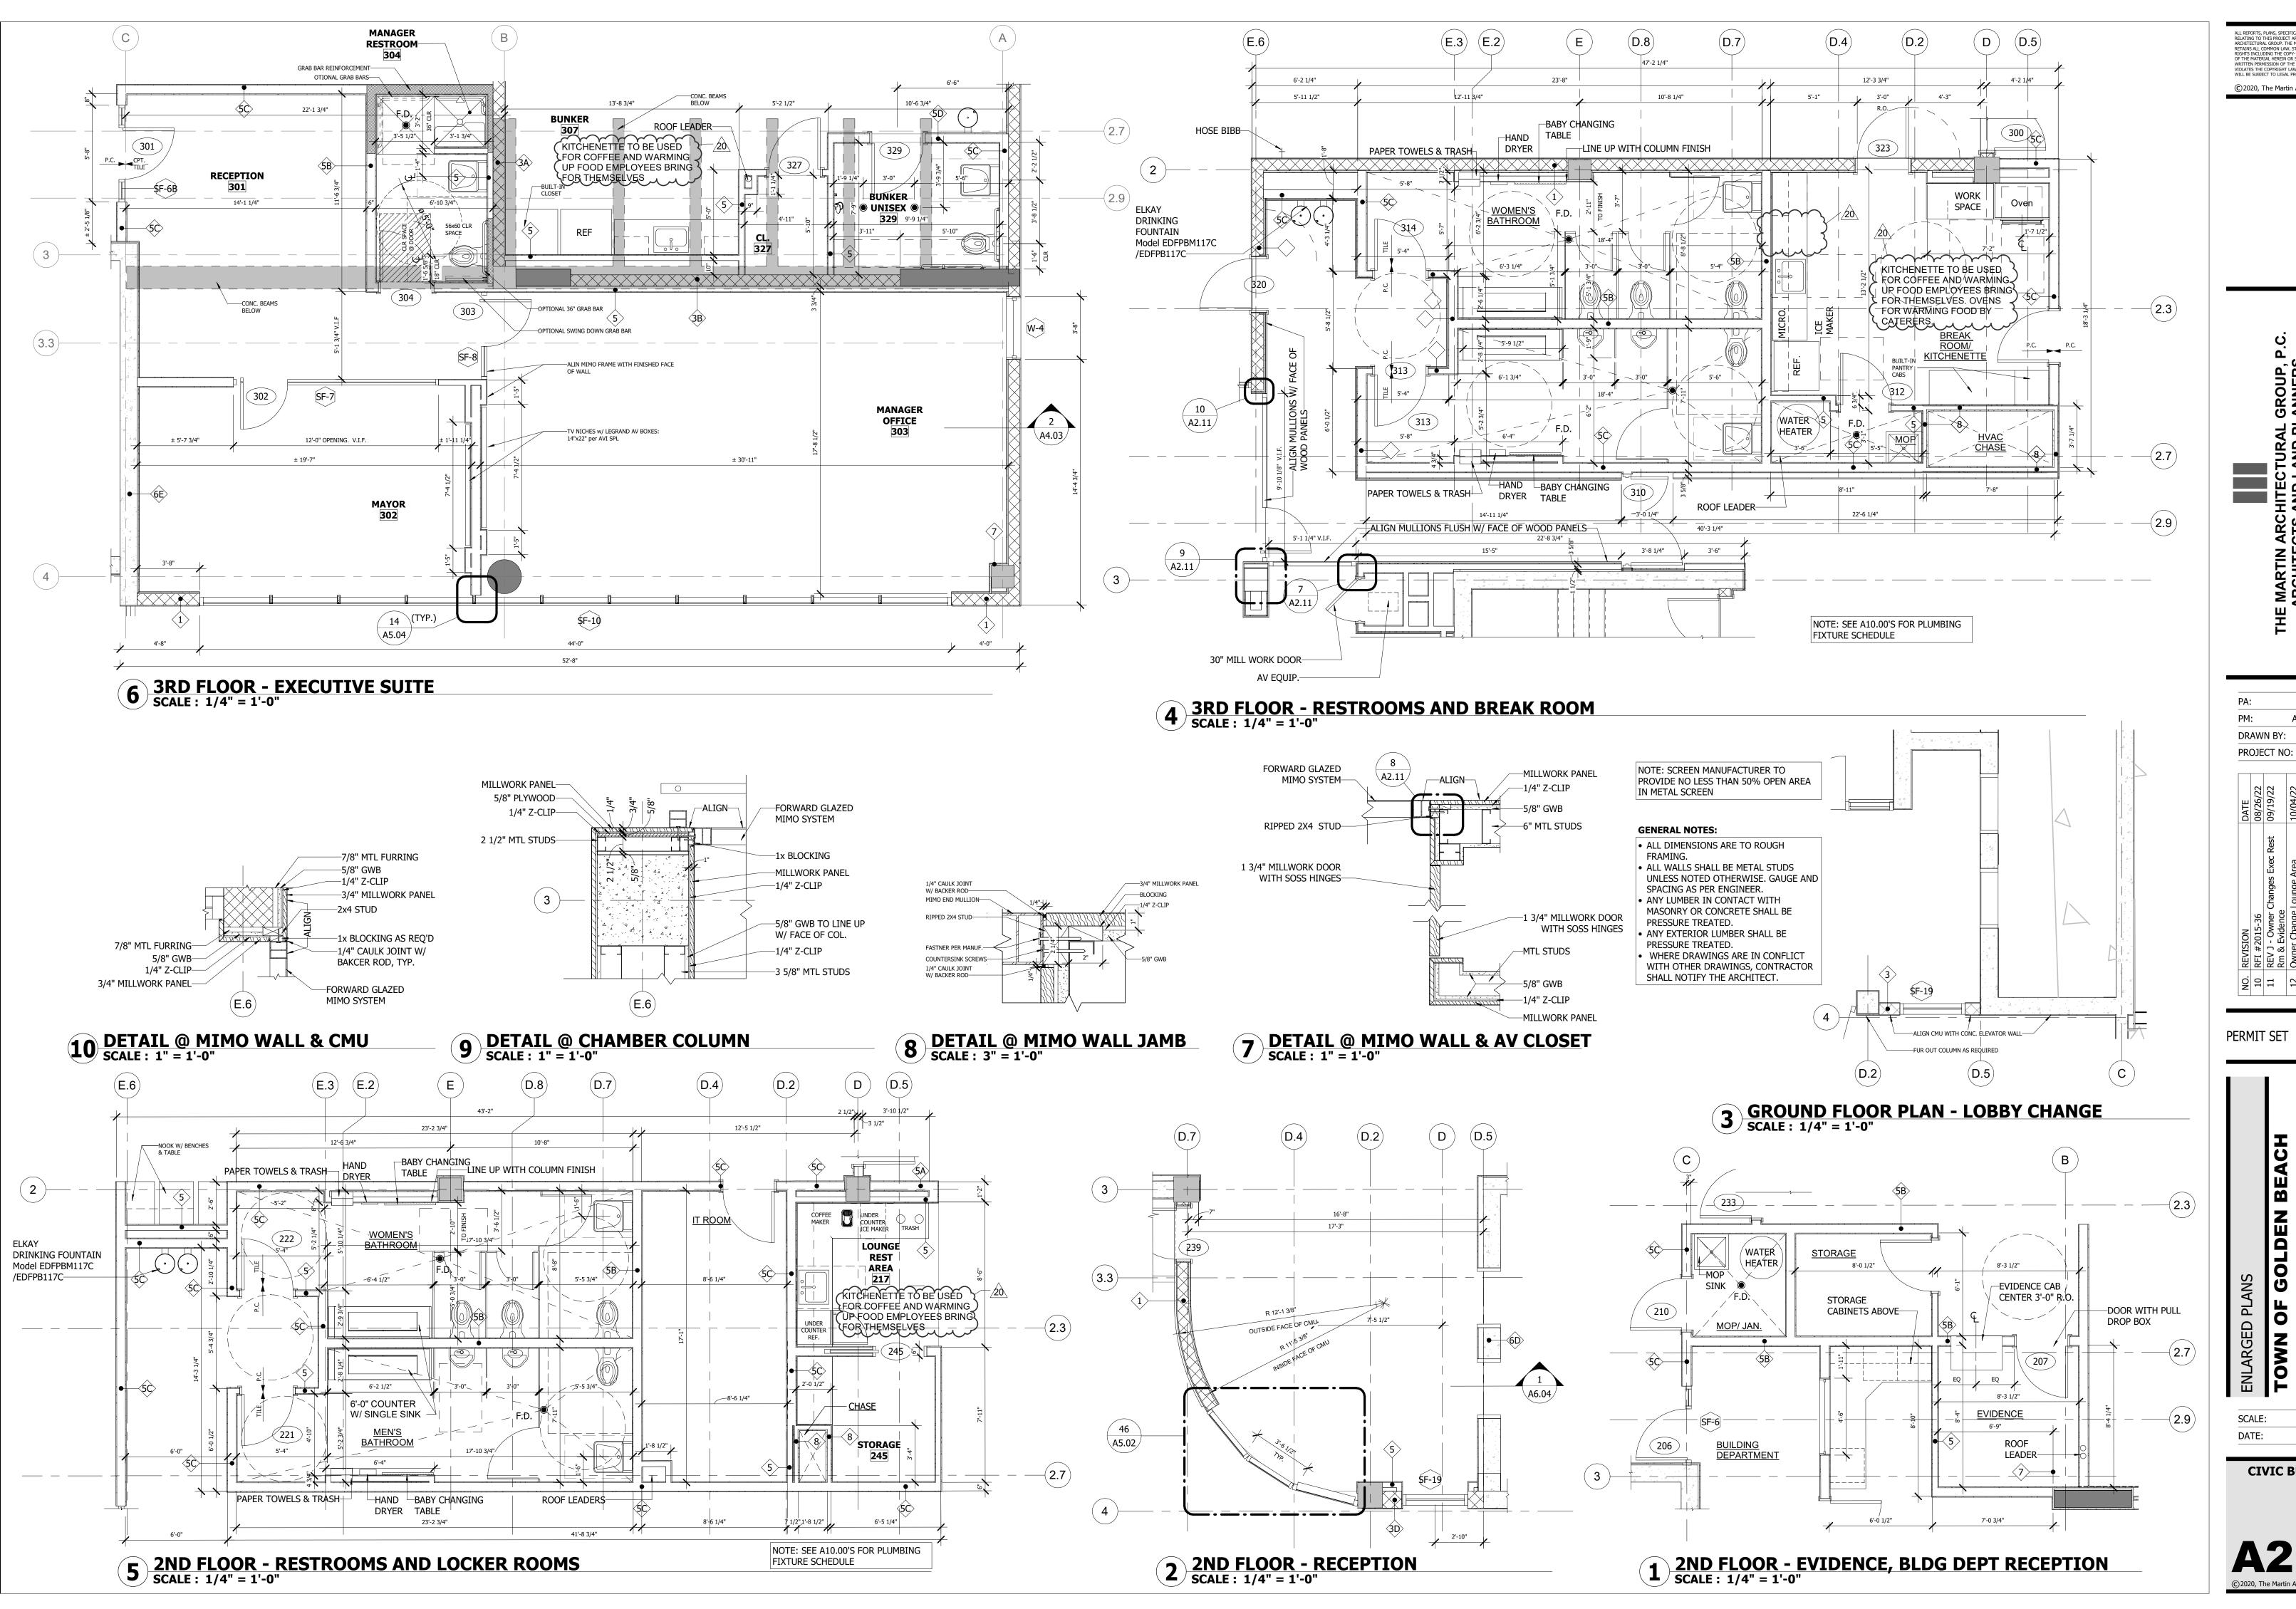


JIM RIVIELLO Annabella Garcia DRAWN BY: 1931-01 PROJECT NO:


PERMIT SET

AS NOTED 03/25/2021

CIVIC BUILDING

2020, The Martin Architectural Group, P.C.

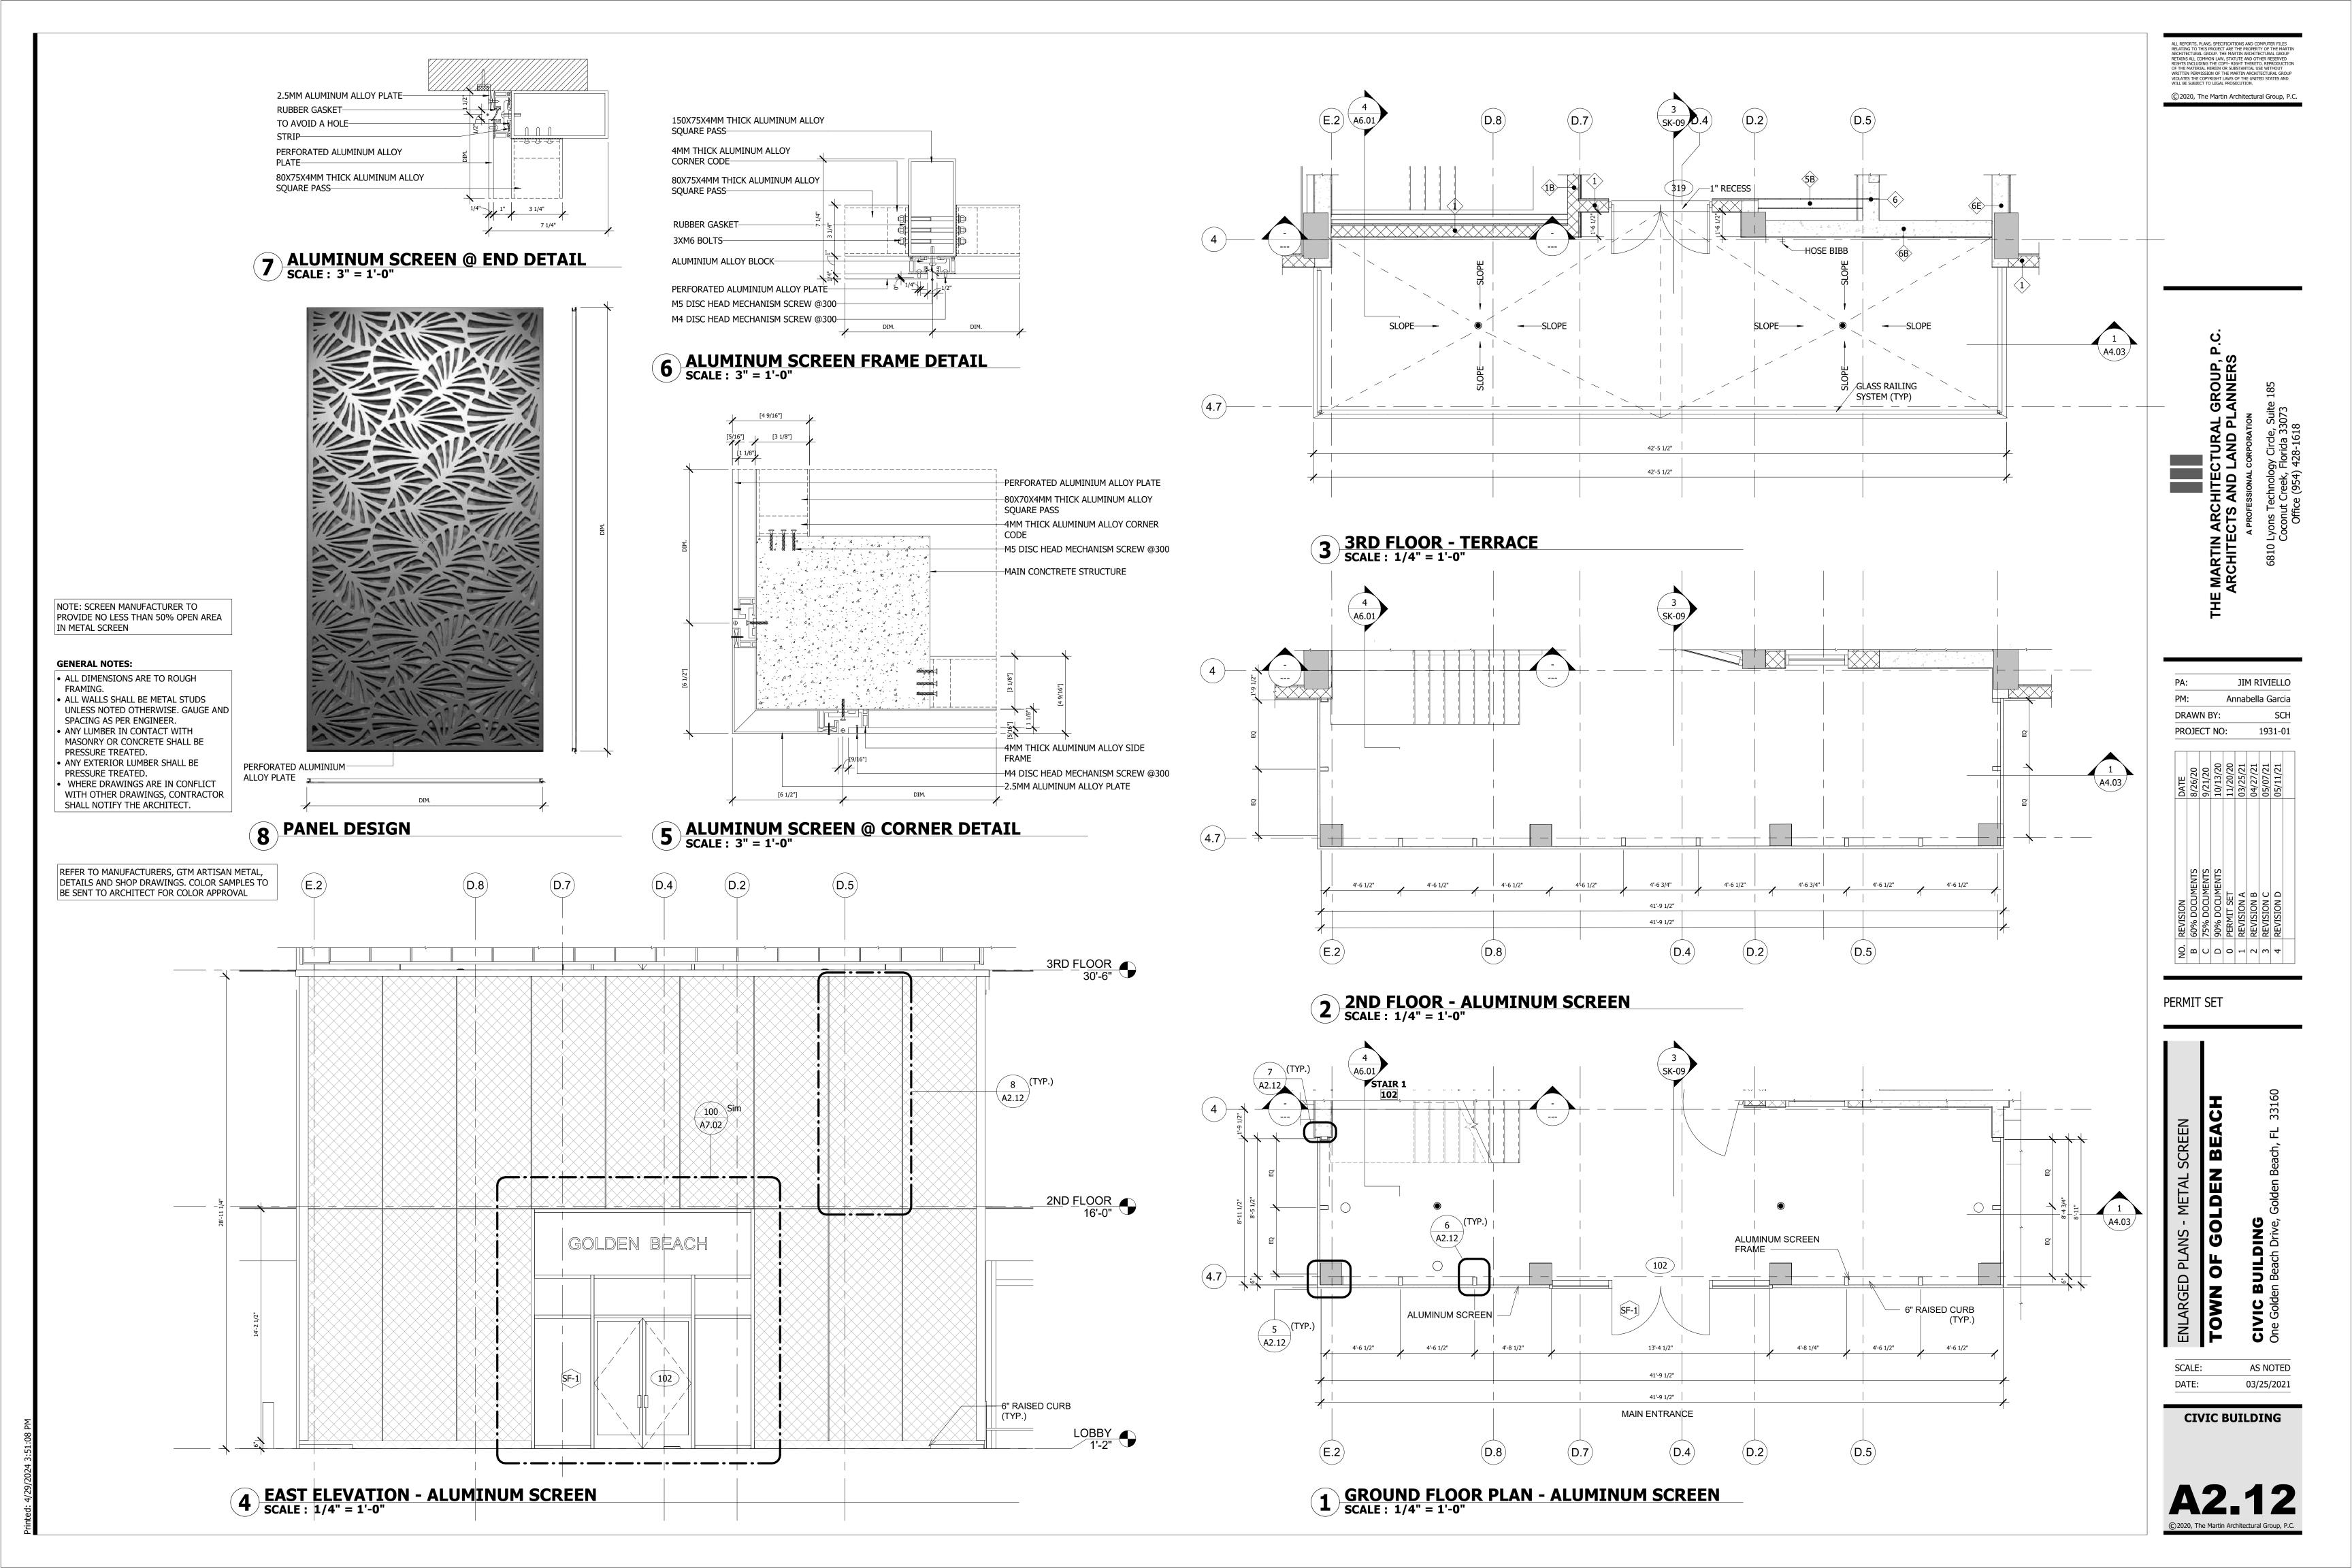

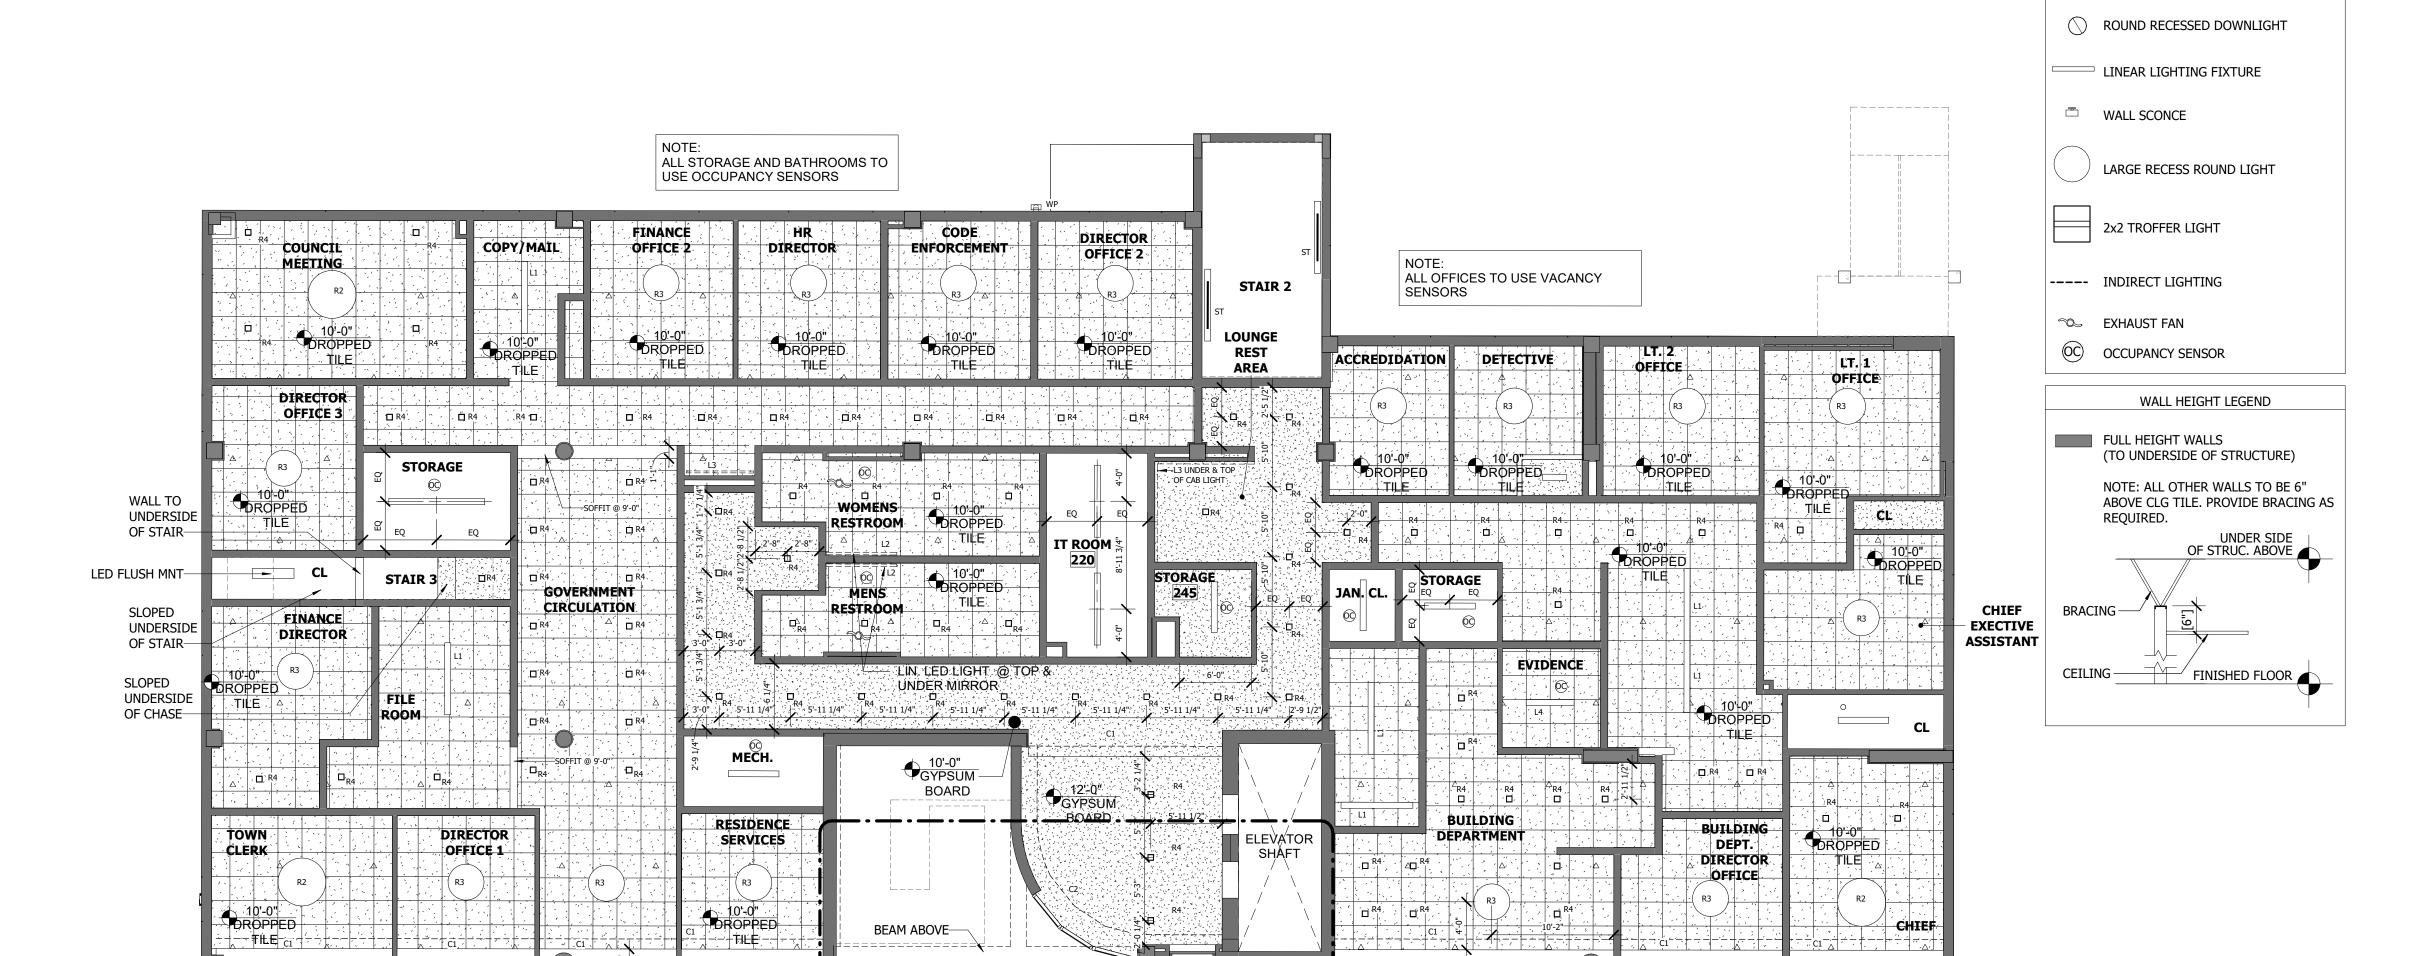

NOTE:

LIGHTING IN GENERAL NEEDS TO BE COORDINATE WITH LIGHTING REP.

TWO STORY SPACE (FROM 2ND FLR)

1 SK-19

PROVIDE AN EXTERIOR SOFFIT @26'-6"

FIELD VERIFY LIGHT LOCATION
DIMENSIONS. CONSULT W/
ARCHITECT BEFORE INSTALLING.

LIGHTING LEGEND

☐ SQUARE RECESSED DOWNLIGHT

EX EXTERIOR RECESS DOWNLIGHT

2ND FLOOR - RCP SCALE: 1/8" = 1'-0"

THE CI

EXTEND FRONT


PORTION TO STRUCTURE (TYP.)


JIM RIVIELLO Annabella Garcia DRAWN BY: PROJECT NO: 1931-01

PERMIT SET

SECOND FLOOR REFLECTED CEILING PLAN
TOWN OF GOLDEN BEACH

SCALE: AS NOTED 03/25/2021

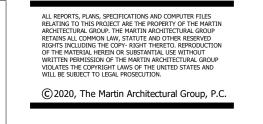

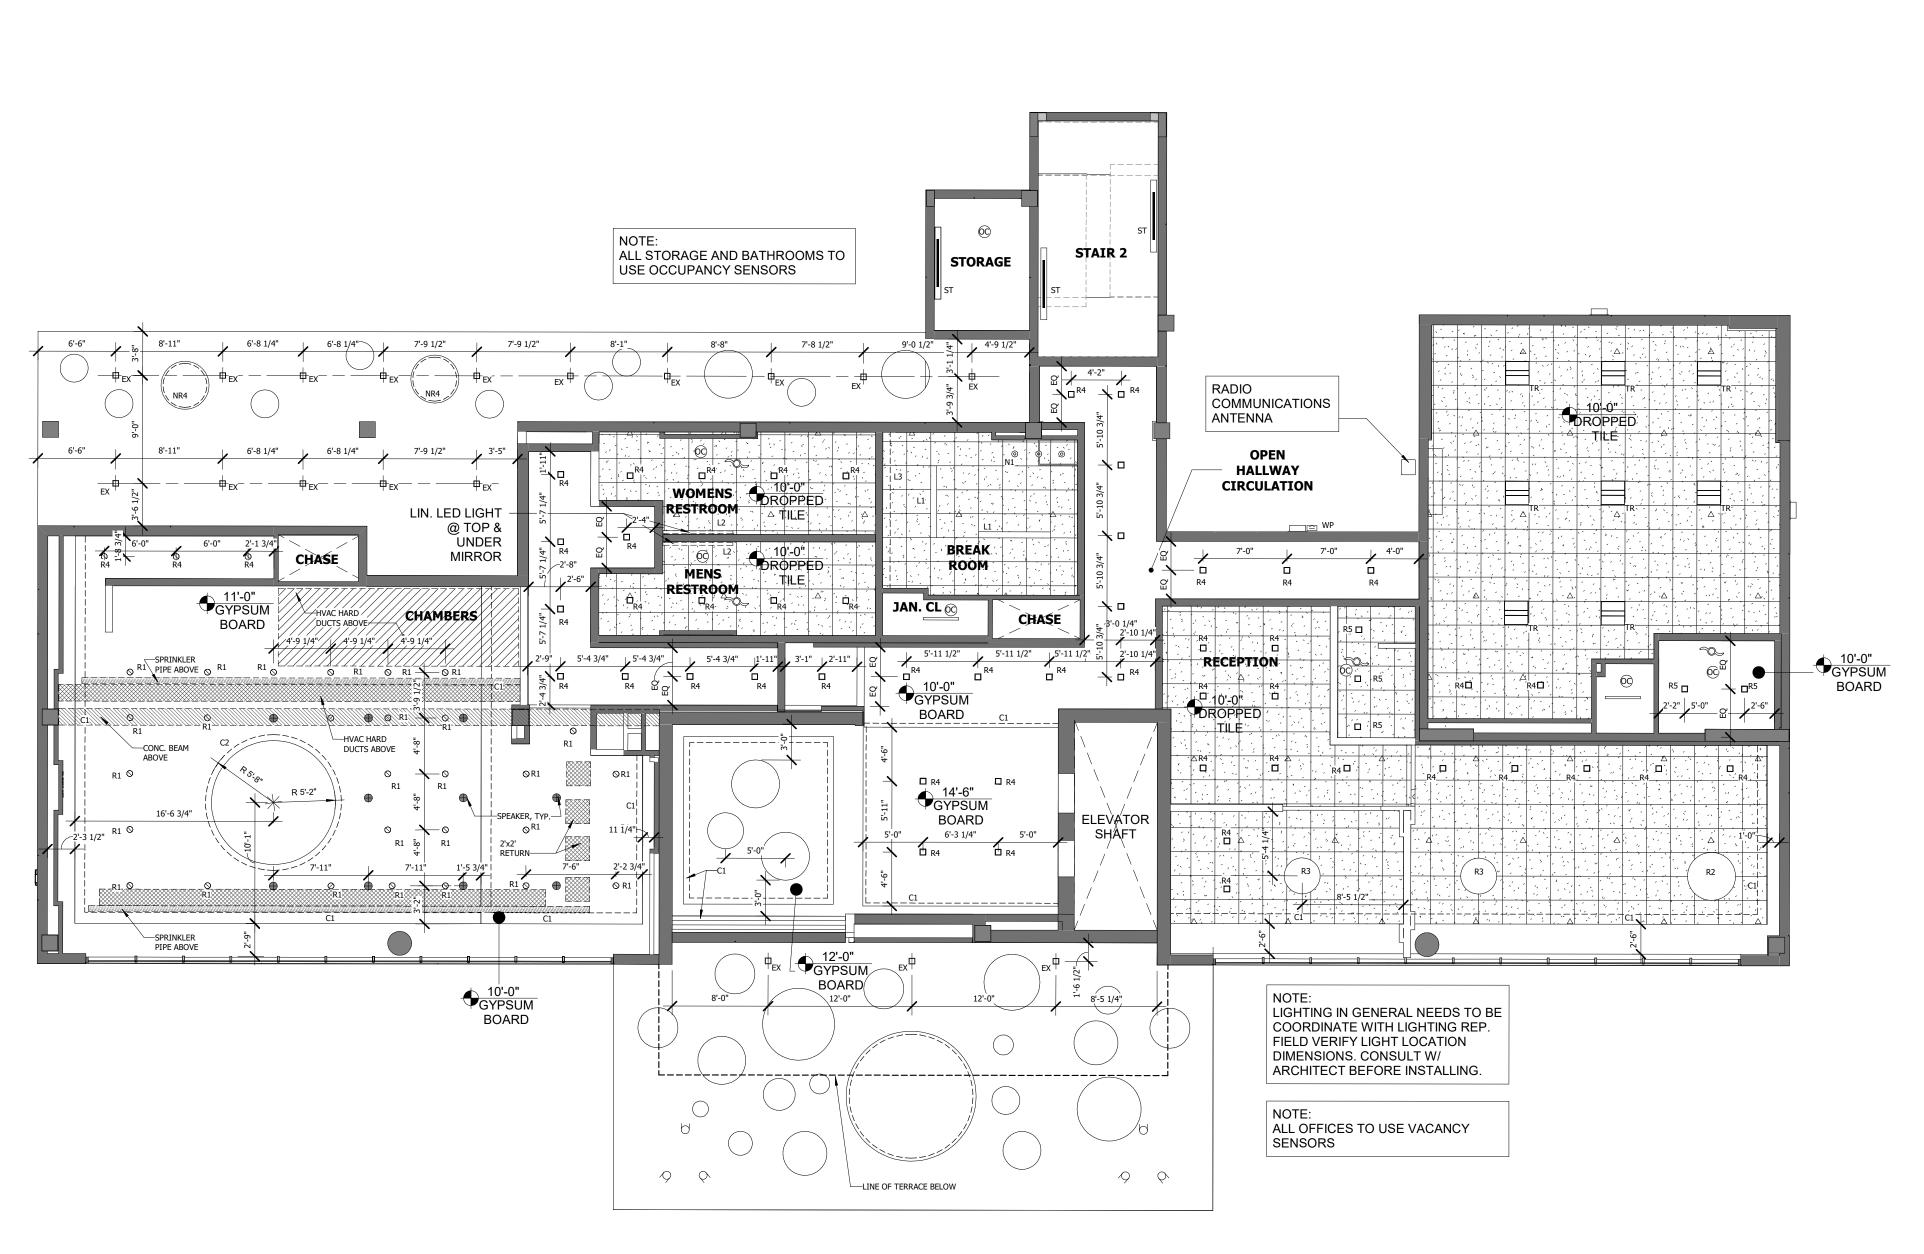

☐ SQUARE RECESSED DOWNLIGHT □EX EXTERIOR RECESS DOWNLIGHT ROUND RECESSED DOWNLIGHT LINEAR LIGHTING FIXTURE WALL SCONCE LARGE RECESS ROUND LIGHT 2x2 TROFFER LIGHT ---- INDIRECT LIGHTING ~ EXHAUST FAN OC OCCUPANCY SENSOR WALL HEIGHT LEGEND FULL HEIGHT WALLS (TO UNDERSIDE OF STRUCTURE) NOTE: ALL OTHER WALLS TO BE 6" ABOVE CLG TILE. PROVIDE BRACING AS REQUIRED. UNDER SIDE OF STRUC. ABOVE BRACING — CEILING FINISHED FLOOR

LIGHTING LEGEND

Annabella Garcia DRAWN BY: PROJECT NO:

JIM RIVIELLO


PERMIT SET


THIRD FLOOR REFLECTED CEILING PLAN
TOWN OF GOLDEN BEACH


AS NOTED 03/25/2021

CIVIC BUILDING

3RD FLOOR - RCP SCALE: 1/8" = 1'-0"

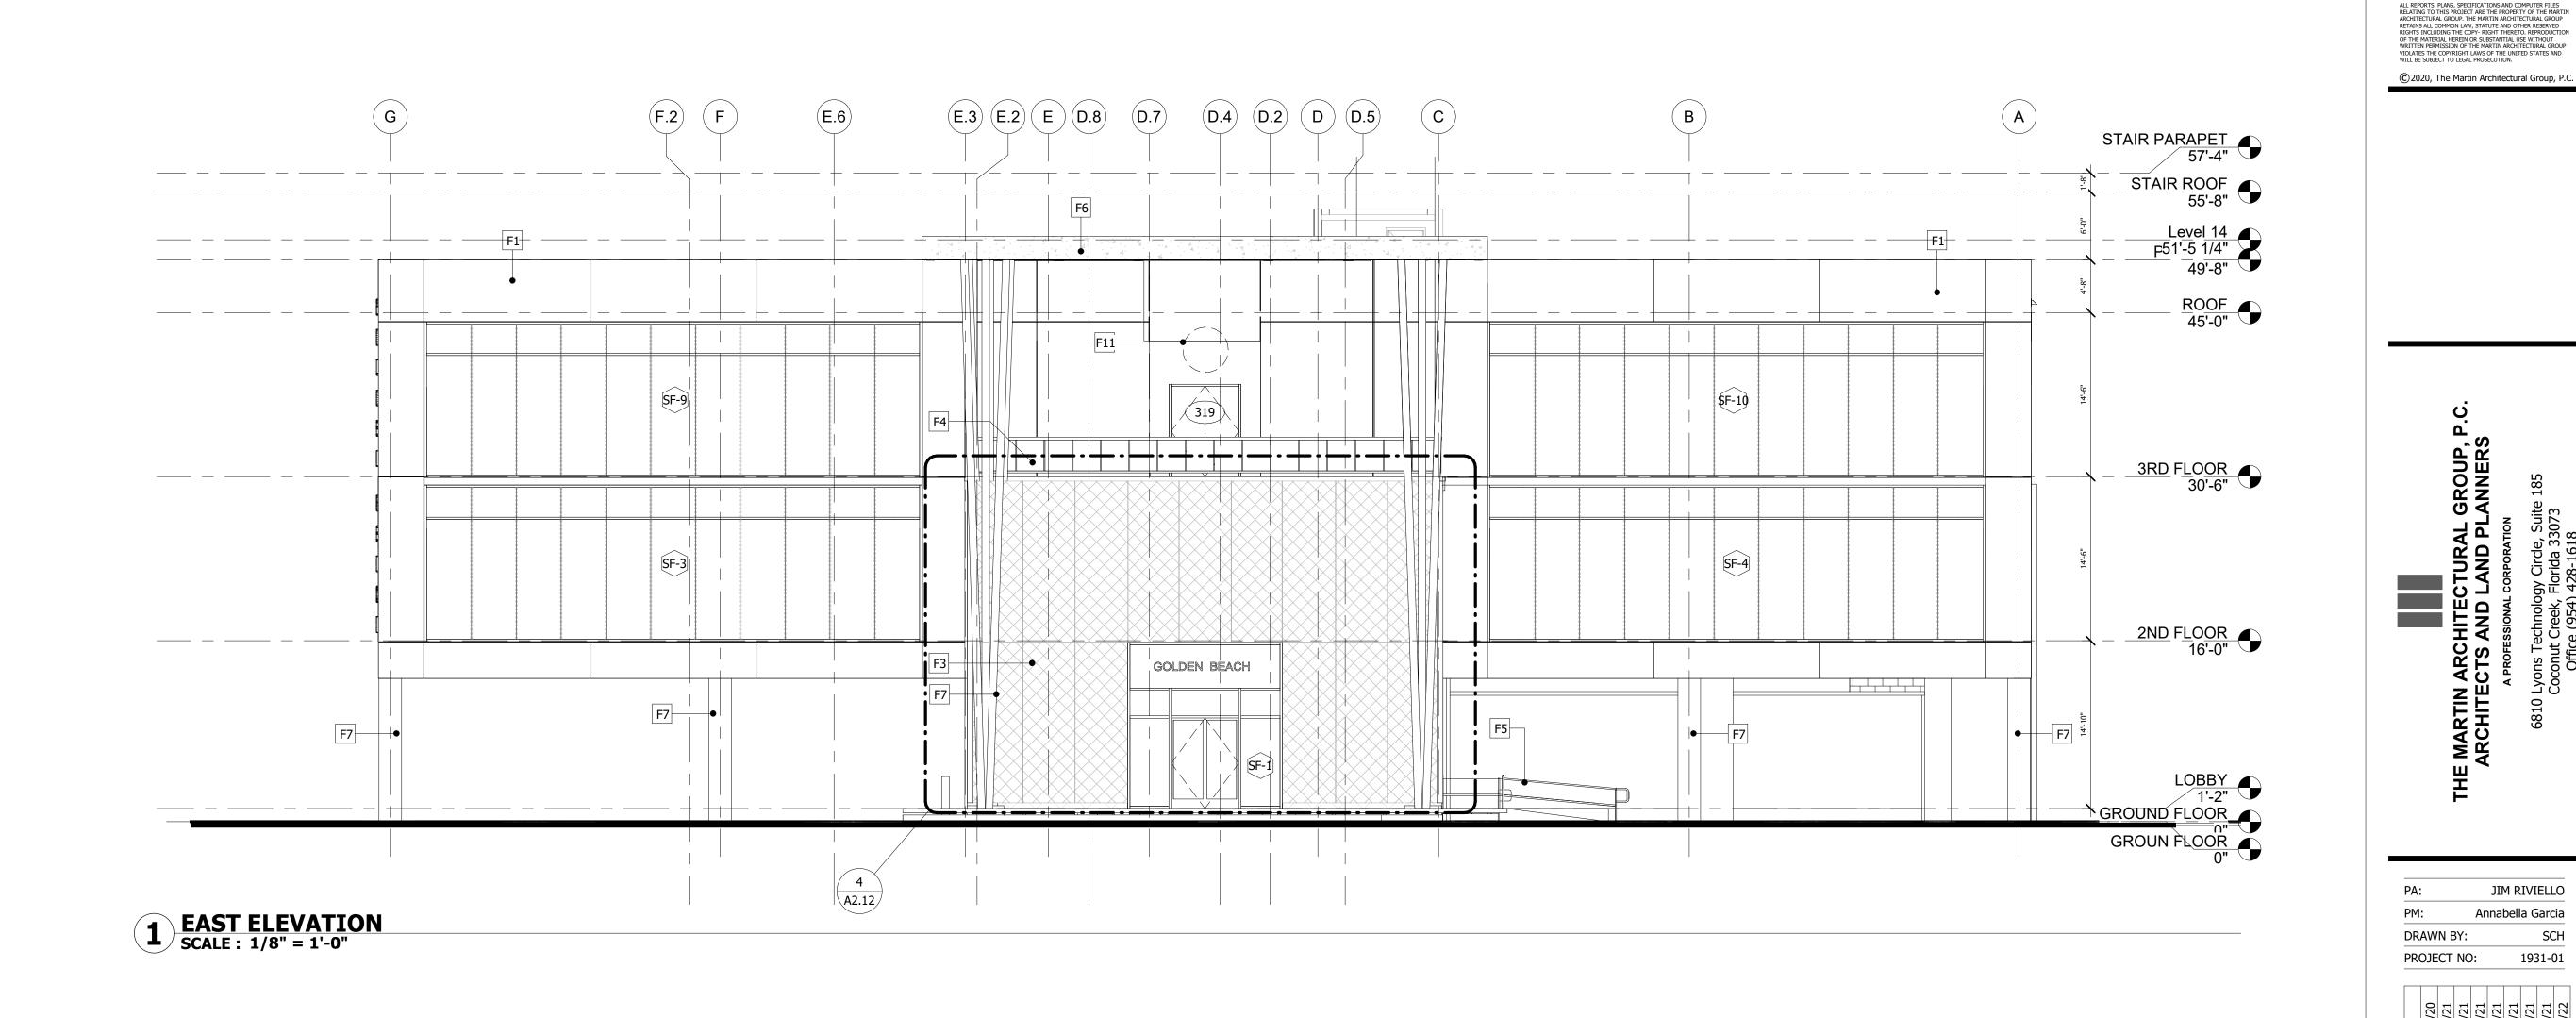

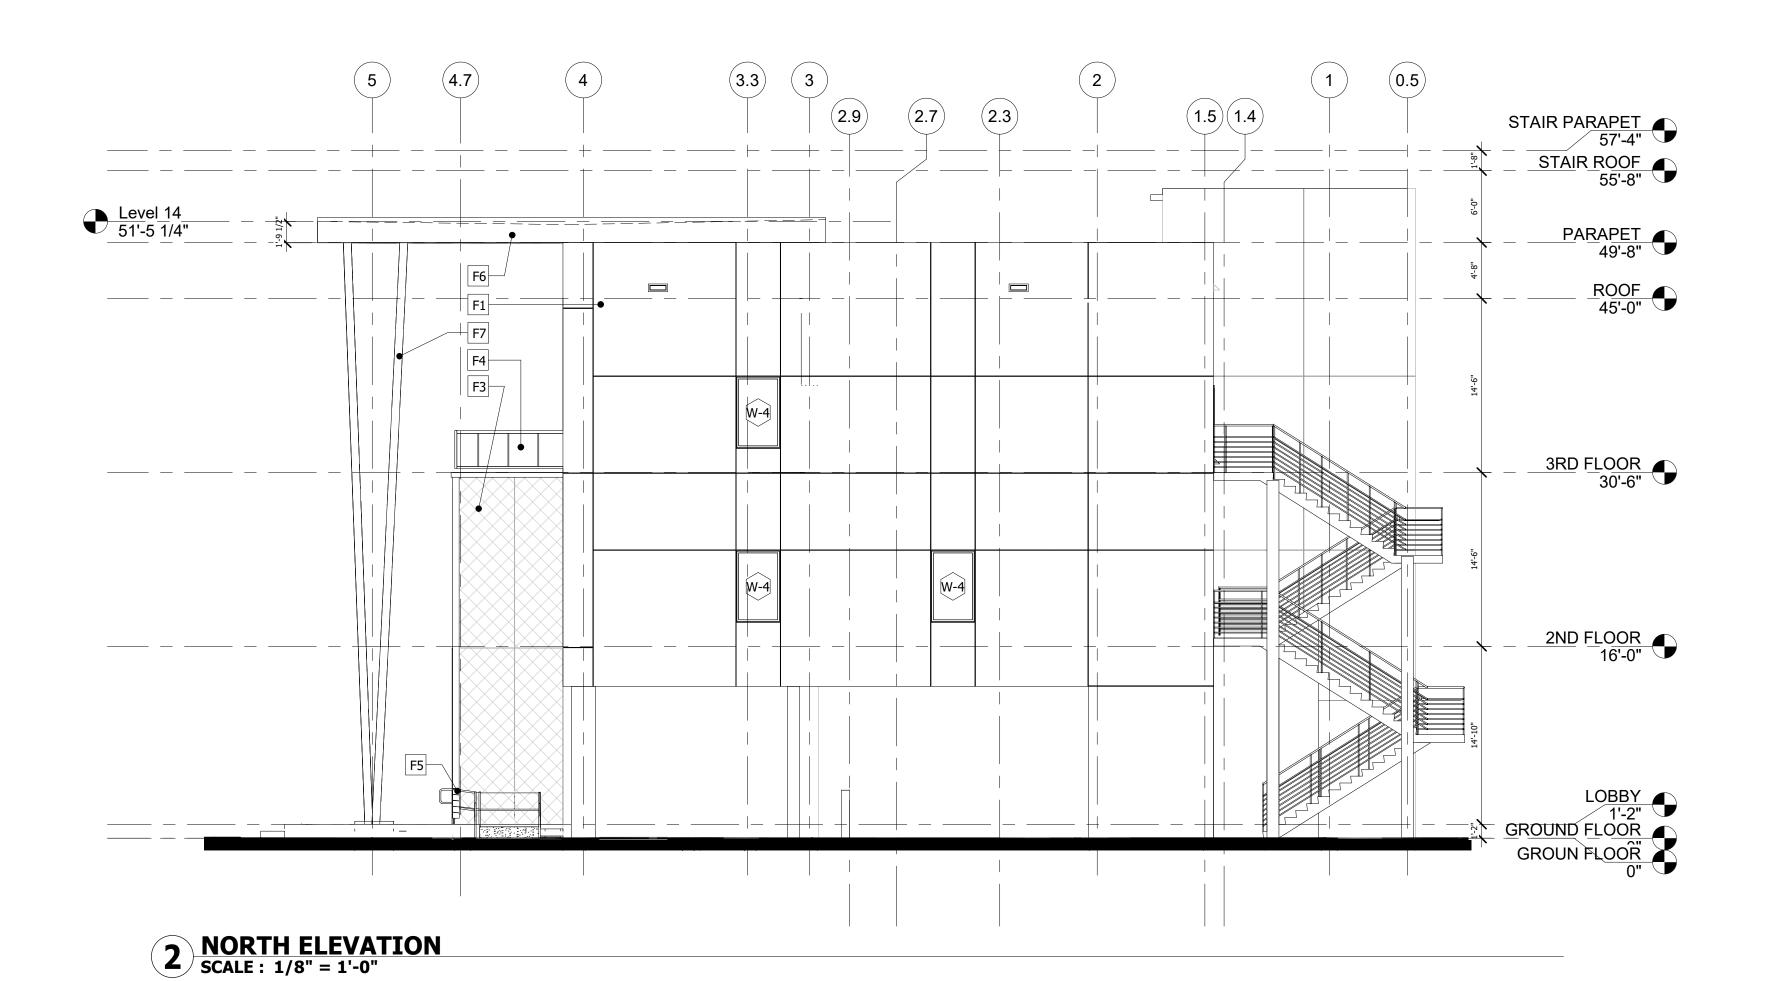

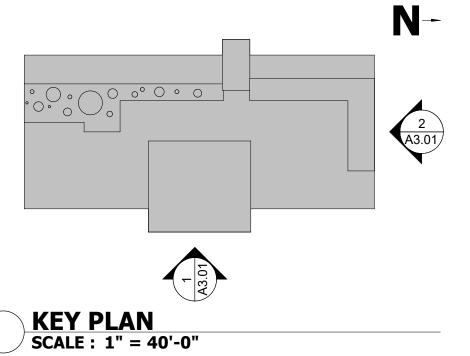

	EXTERIOR FINISH LEGEND
Keynote Tag	Description
F1	PAINTED CEMENT PLASTER
F2	BACKLIT CHANNEL LETTERS
F3	PERFORATED ALUMINUM SCREEN
F4	CLEAR IMPACT GLASS RAILING
F5	42" HIGH ALUMINUM RAILING
F6	METAL STUD AND TUBING CANOPY WITH PAINTED CEMENT PLASTER FINISH
F7	CONCRETE COLUMN WITH PAINTED CEMENT PLASTER FINISH
F8	CONCRETE BOLLARD
F9	6" CONCRETE CURB
F11	SEAL OF GOLDEN BEACH

THE MARTIN ARCHITECTURAL GROUP, P.C.
ARCHITECTS AND LAND PLANNERS
A PROFESSIONAL CORPORATION

JIM RIVIELLO

SCH

1931-01

Annabella Garcia


DRAWN BY:

PERMIT SET

PROJECT NO:

ELEVATIONS
TOWN OF GOLDEN BEACH

SCALE: AS NOTED 03/25/2021

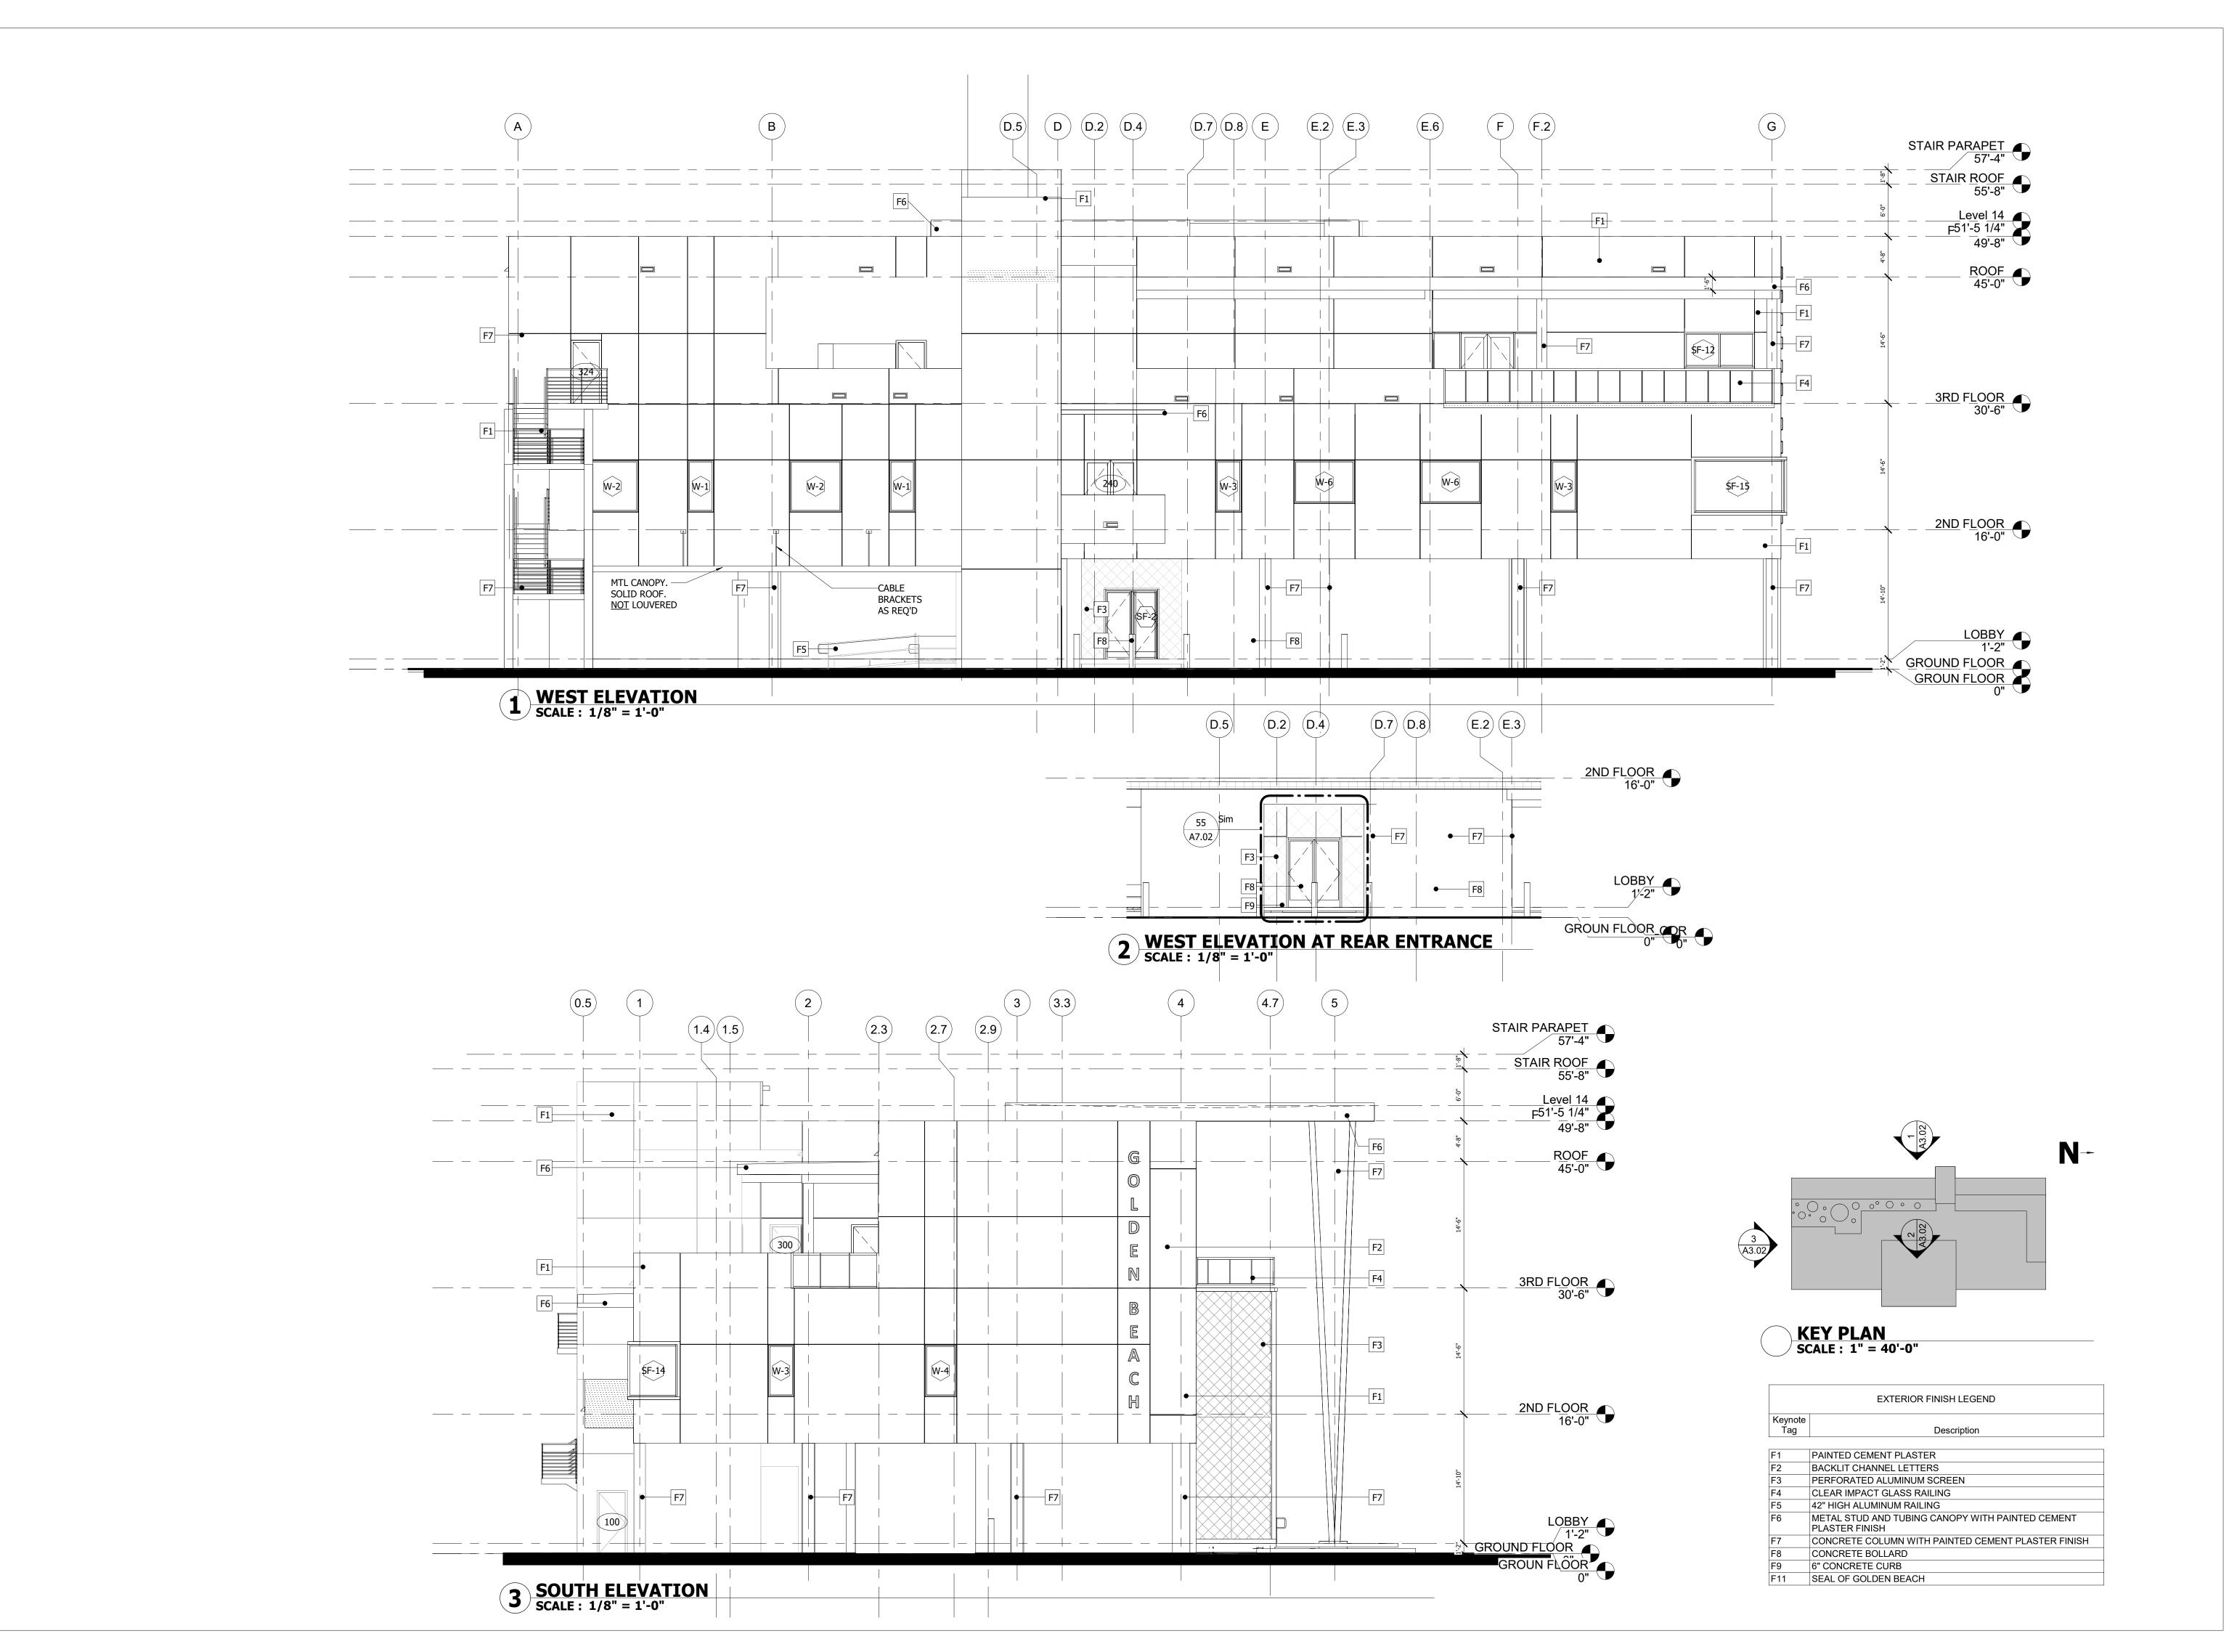

Annabella Garcia DRAWN BY: PROJECT NO: 1931-01

JIM RIVIELLO

PERMIT SET

ELEVATIONS
TOWN OF GOLDEN BEACH

SCALE: AS NOTED 03/25/2021

2 SOUTH PERSPECTIVE SCALE:



4 NORTH PERSPECTIVE SCALE:



1 EAST PERSPECTIVE SCALE:



WEST PERSPECTIVE SCALE:

JIM RIVIELLO


PERMIT SET


PERSPECTIVES
TOWN OF GOLDEN BEACH


AS NOTED 03/25/2021

CIVIC BUILDING

A3_03
© 2020, The Martin Architectural Group, P.C.

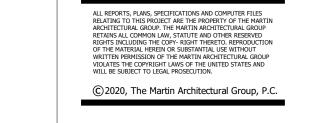

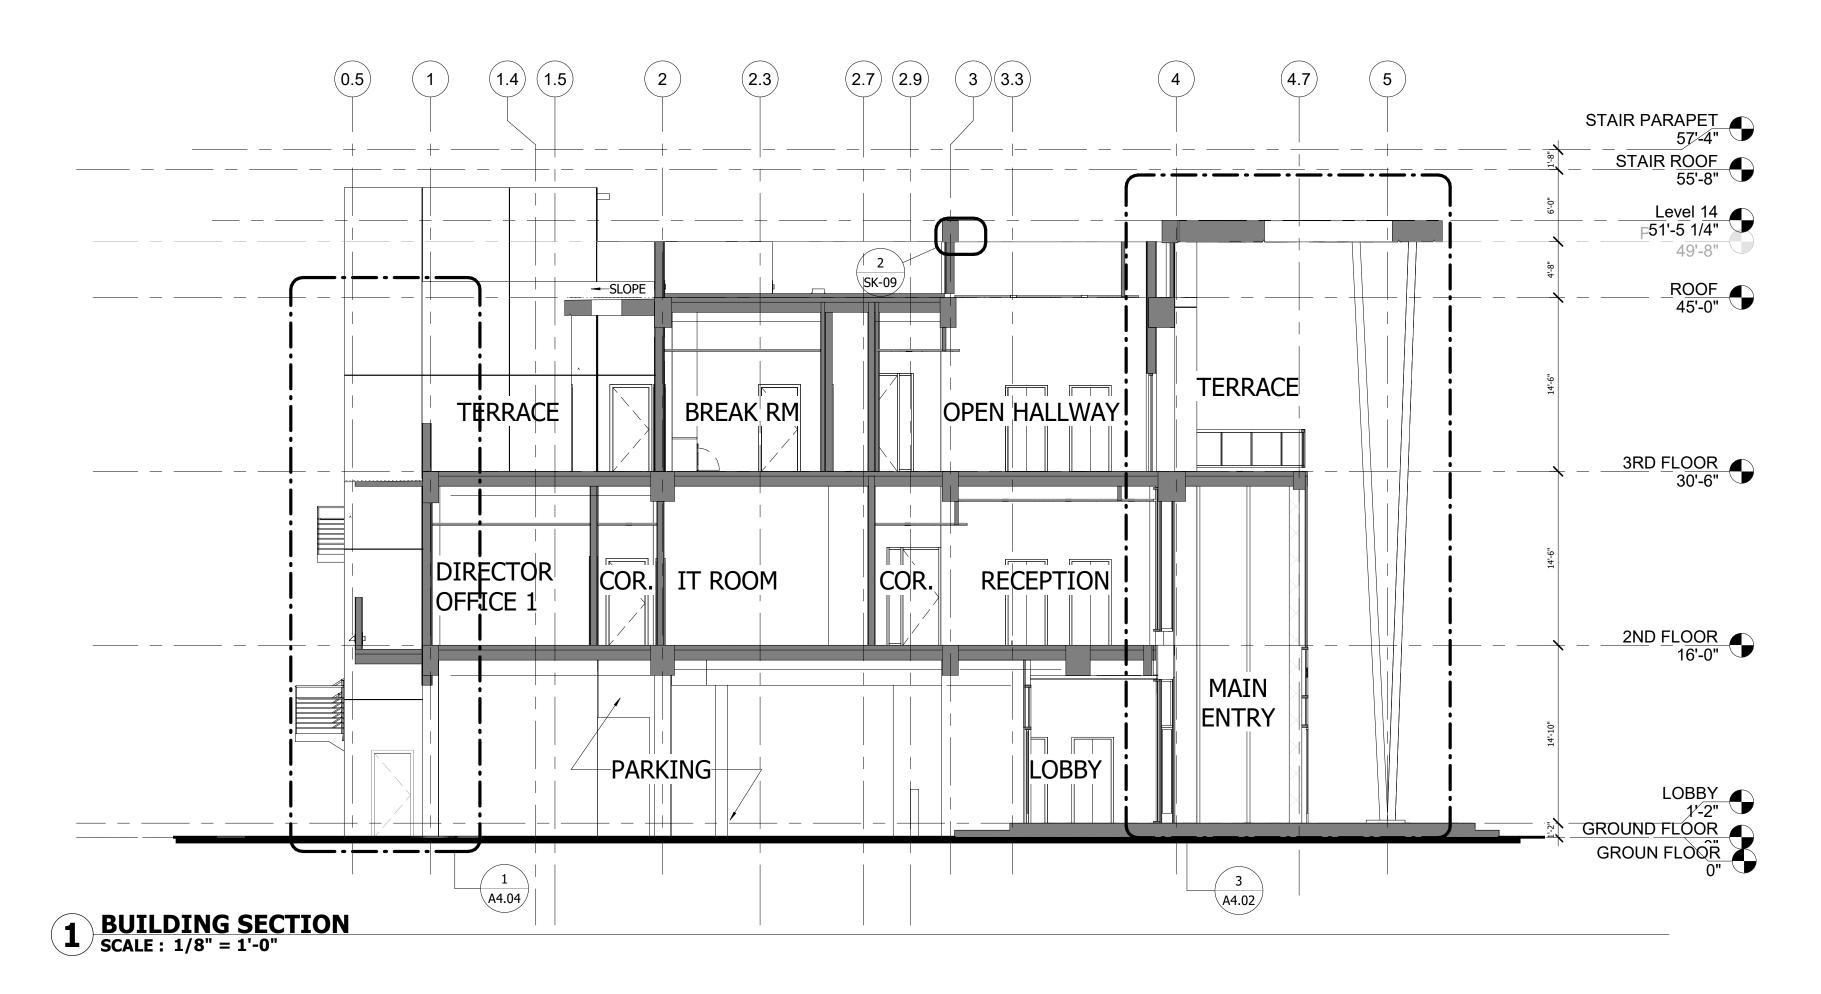

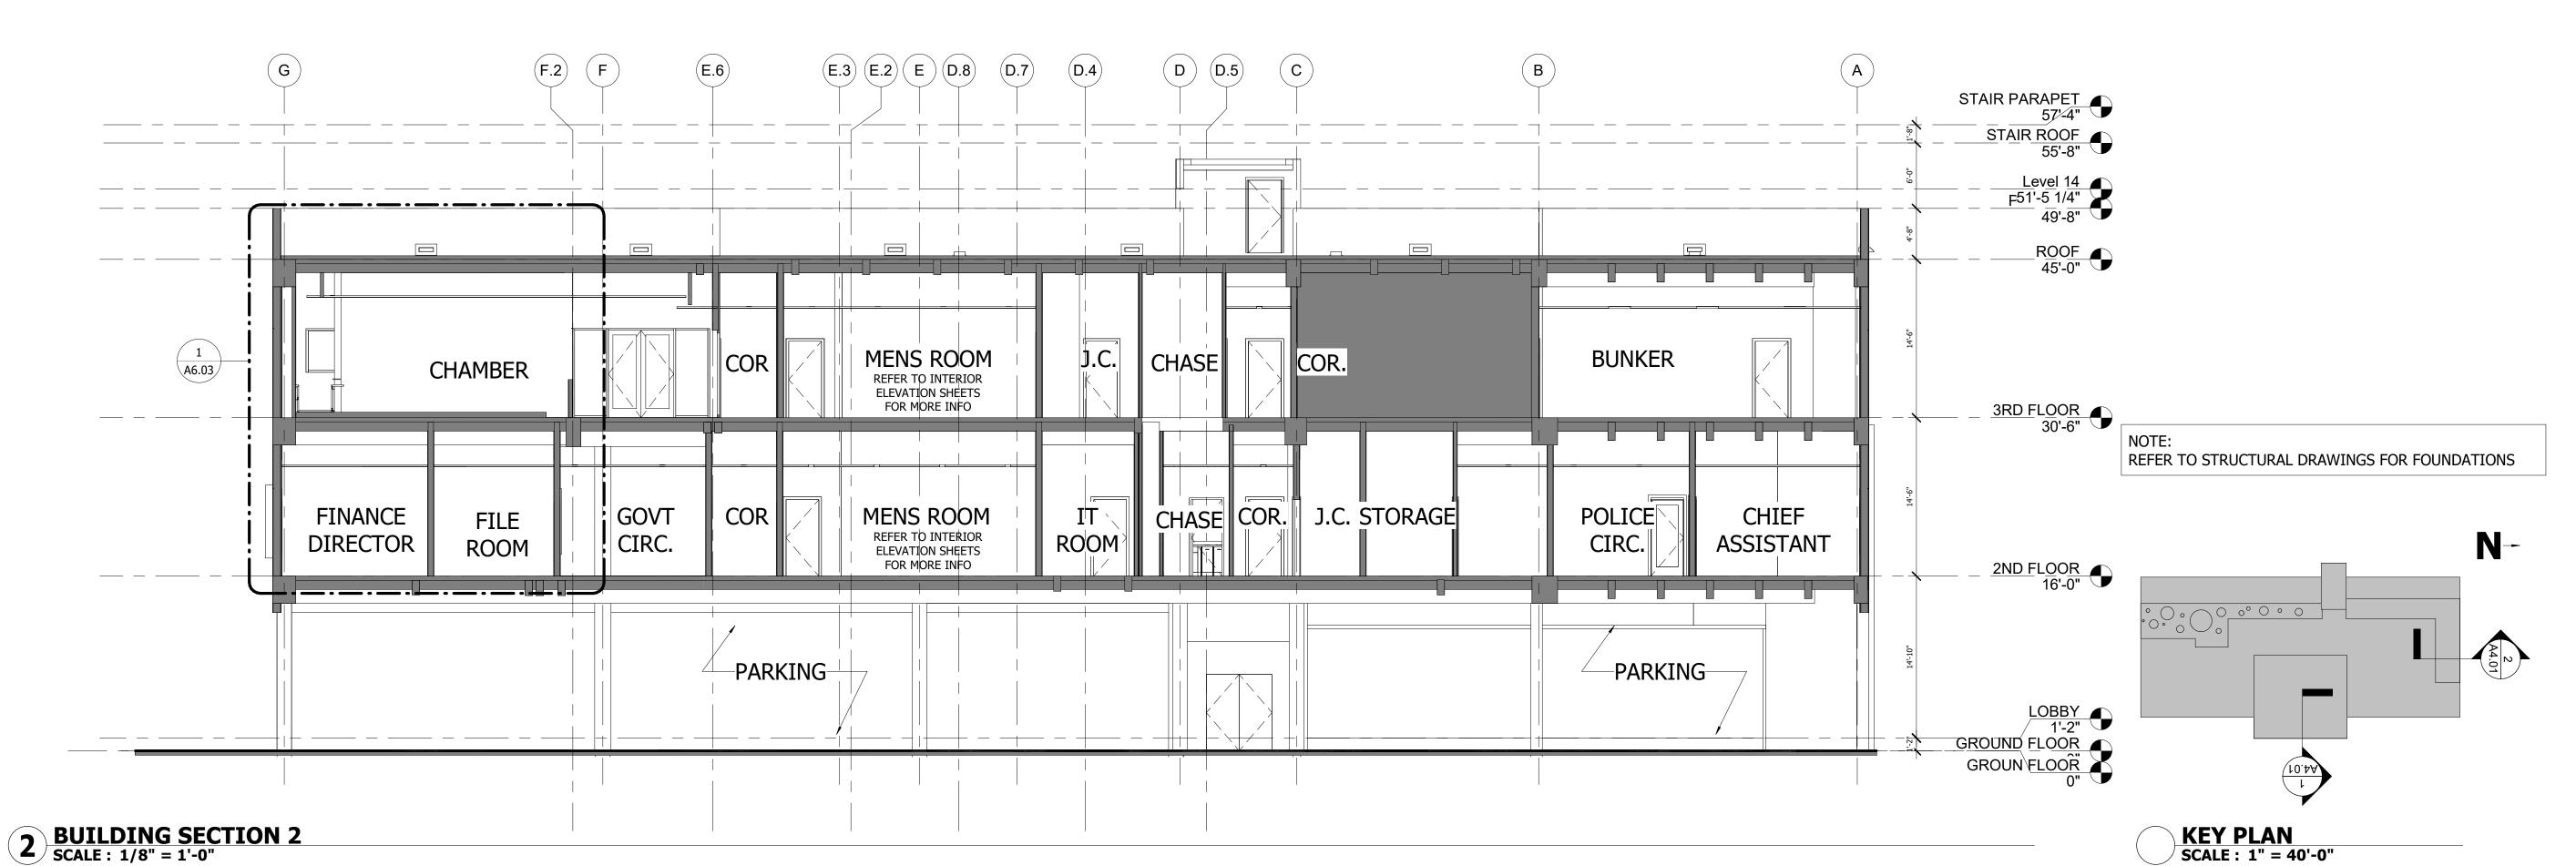


JIM RIVIELLO Annabella Garcia 1931-01

THE MARTIN ARCHITECTURAL GROUP, P. ARCHITECTS AND LAND PLANNERS

PERMIT SET

SECTIONS
TOWN OF GOLDEN BEACH

AS NOTED 03/25/2021

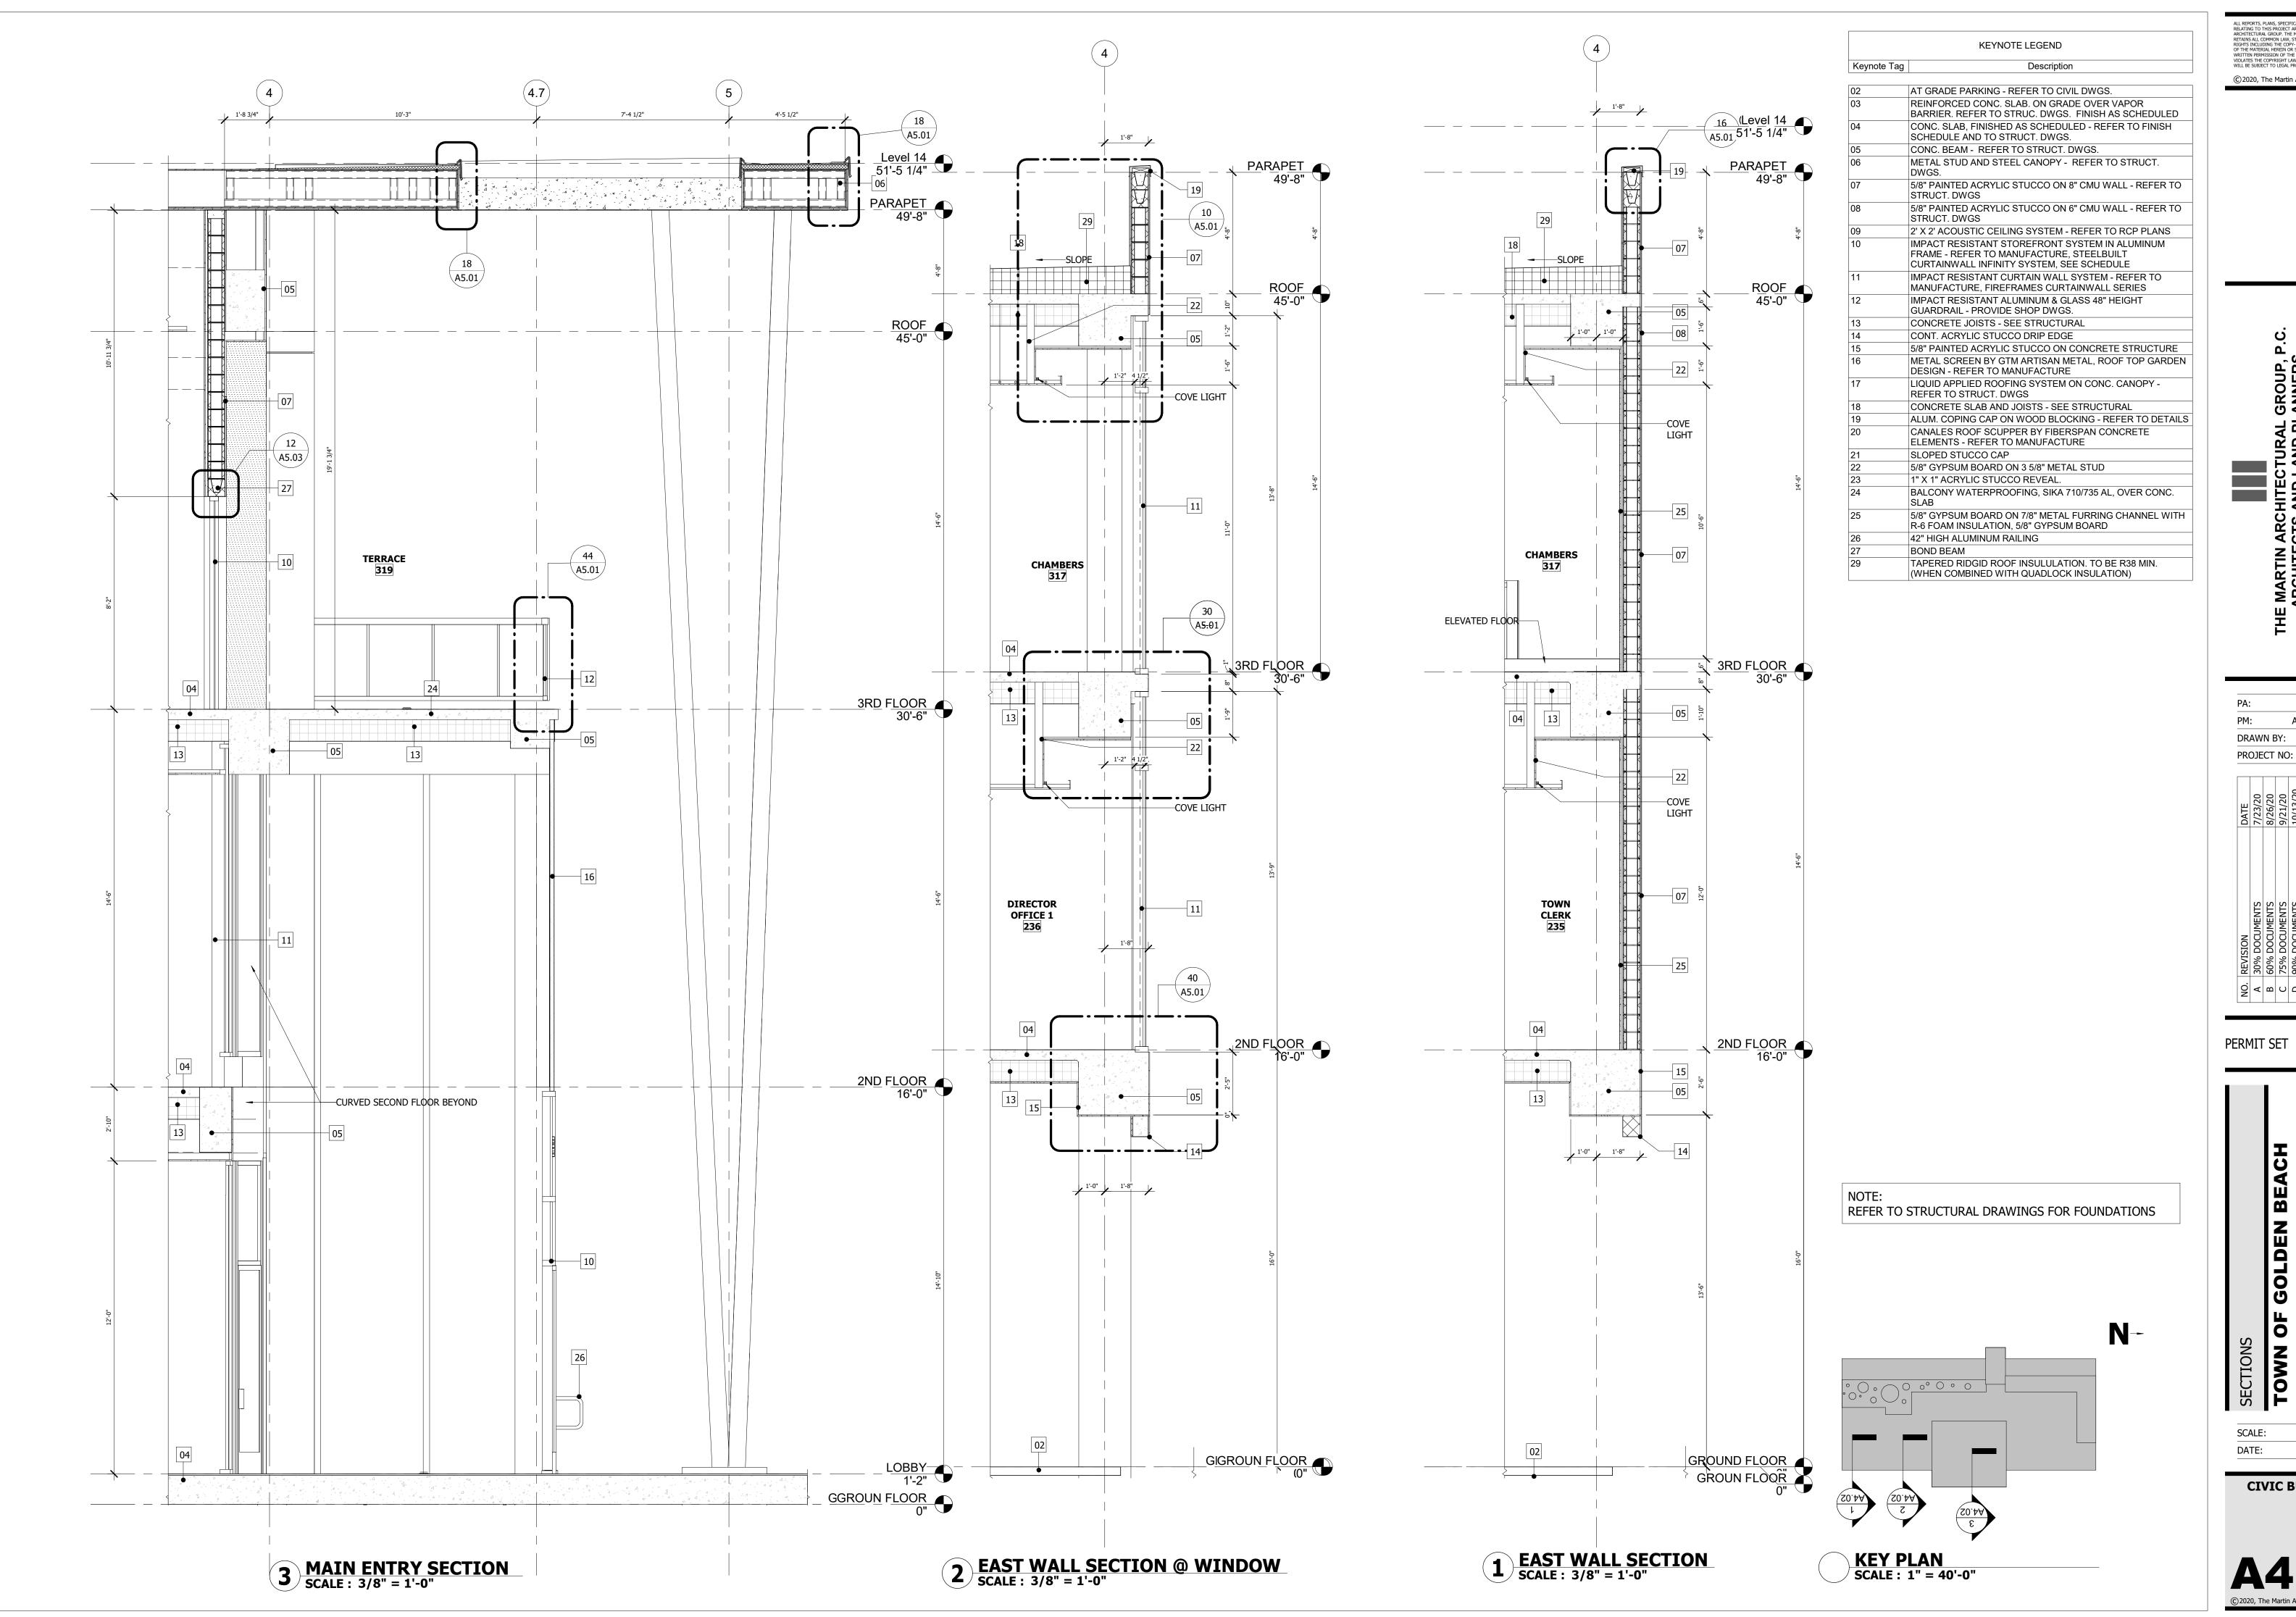


MARTIN ARCHITECTURAL GROUP, ARCHITECTS AND LAND PLANNERS

Annabella Garcia DRAWN BY: SCH PROJECT NO: 1931-01

JIM RIVIELLO

AS NOTED 03/25/2021

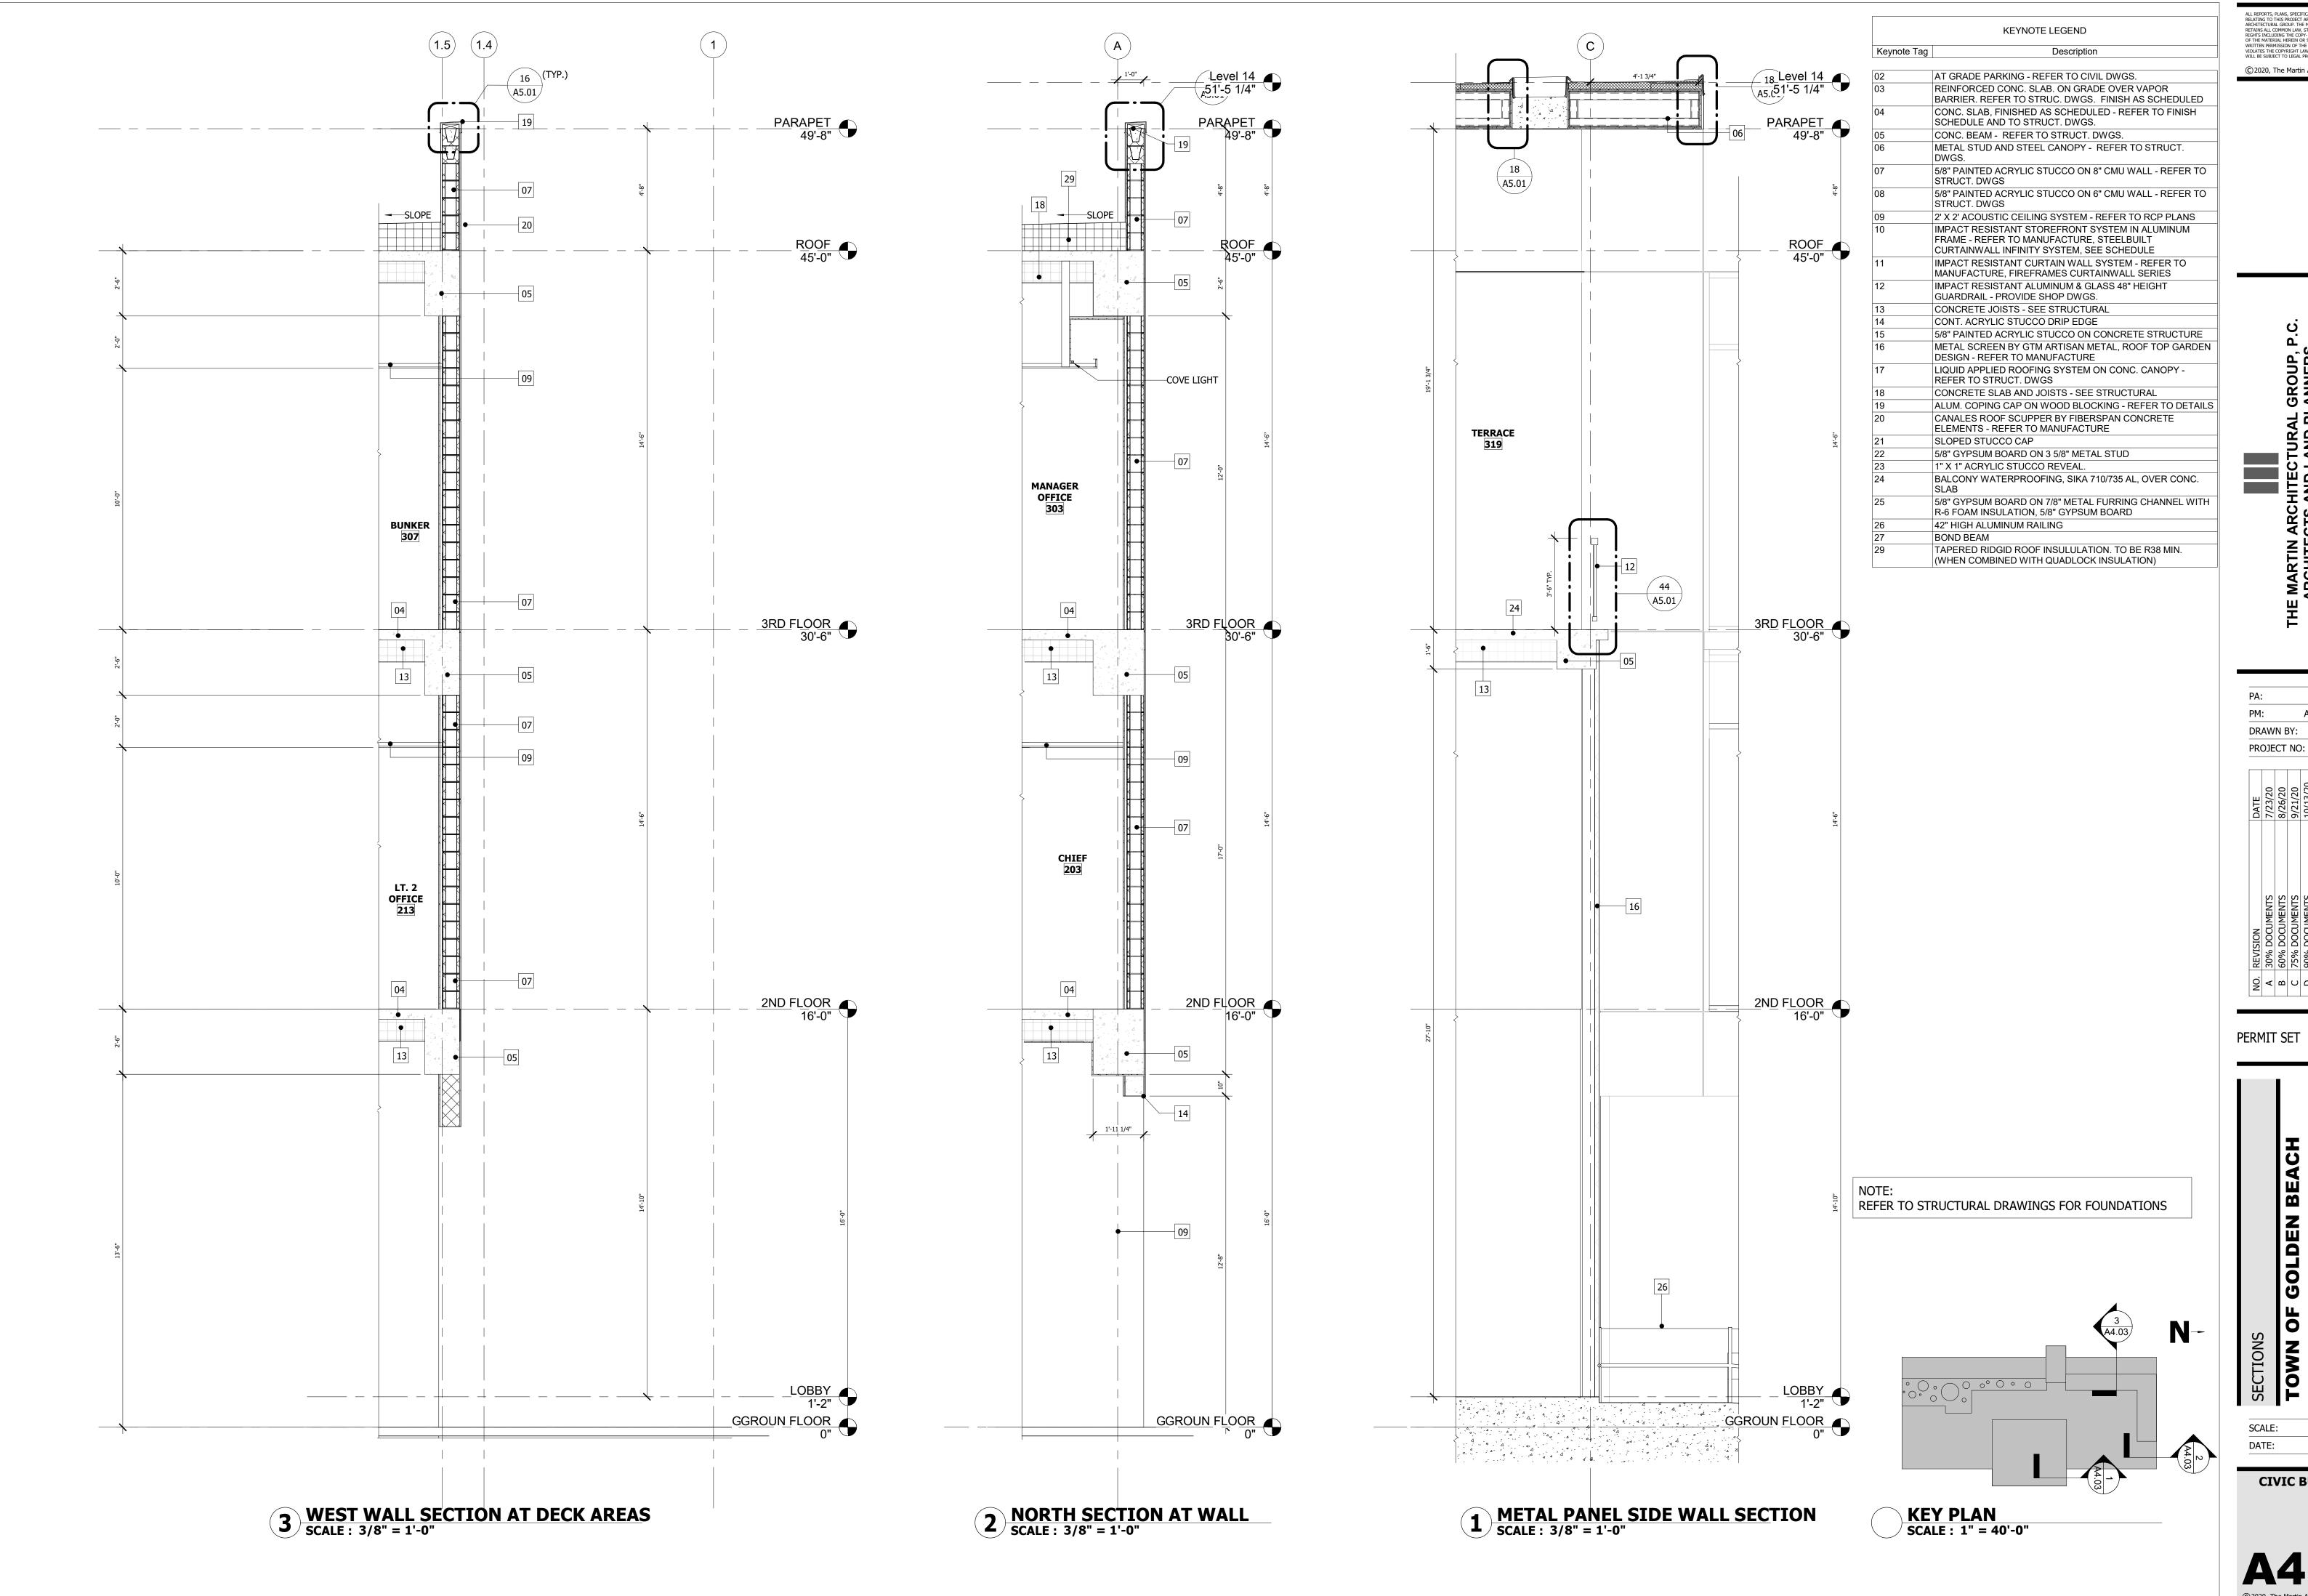


PROJECT NO: 1931-01

JIM RIVIELLO Annabella Garcia

PERMIT SET

AS NOTED 03/25/2021

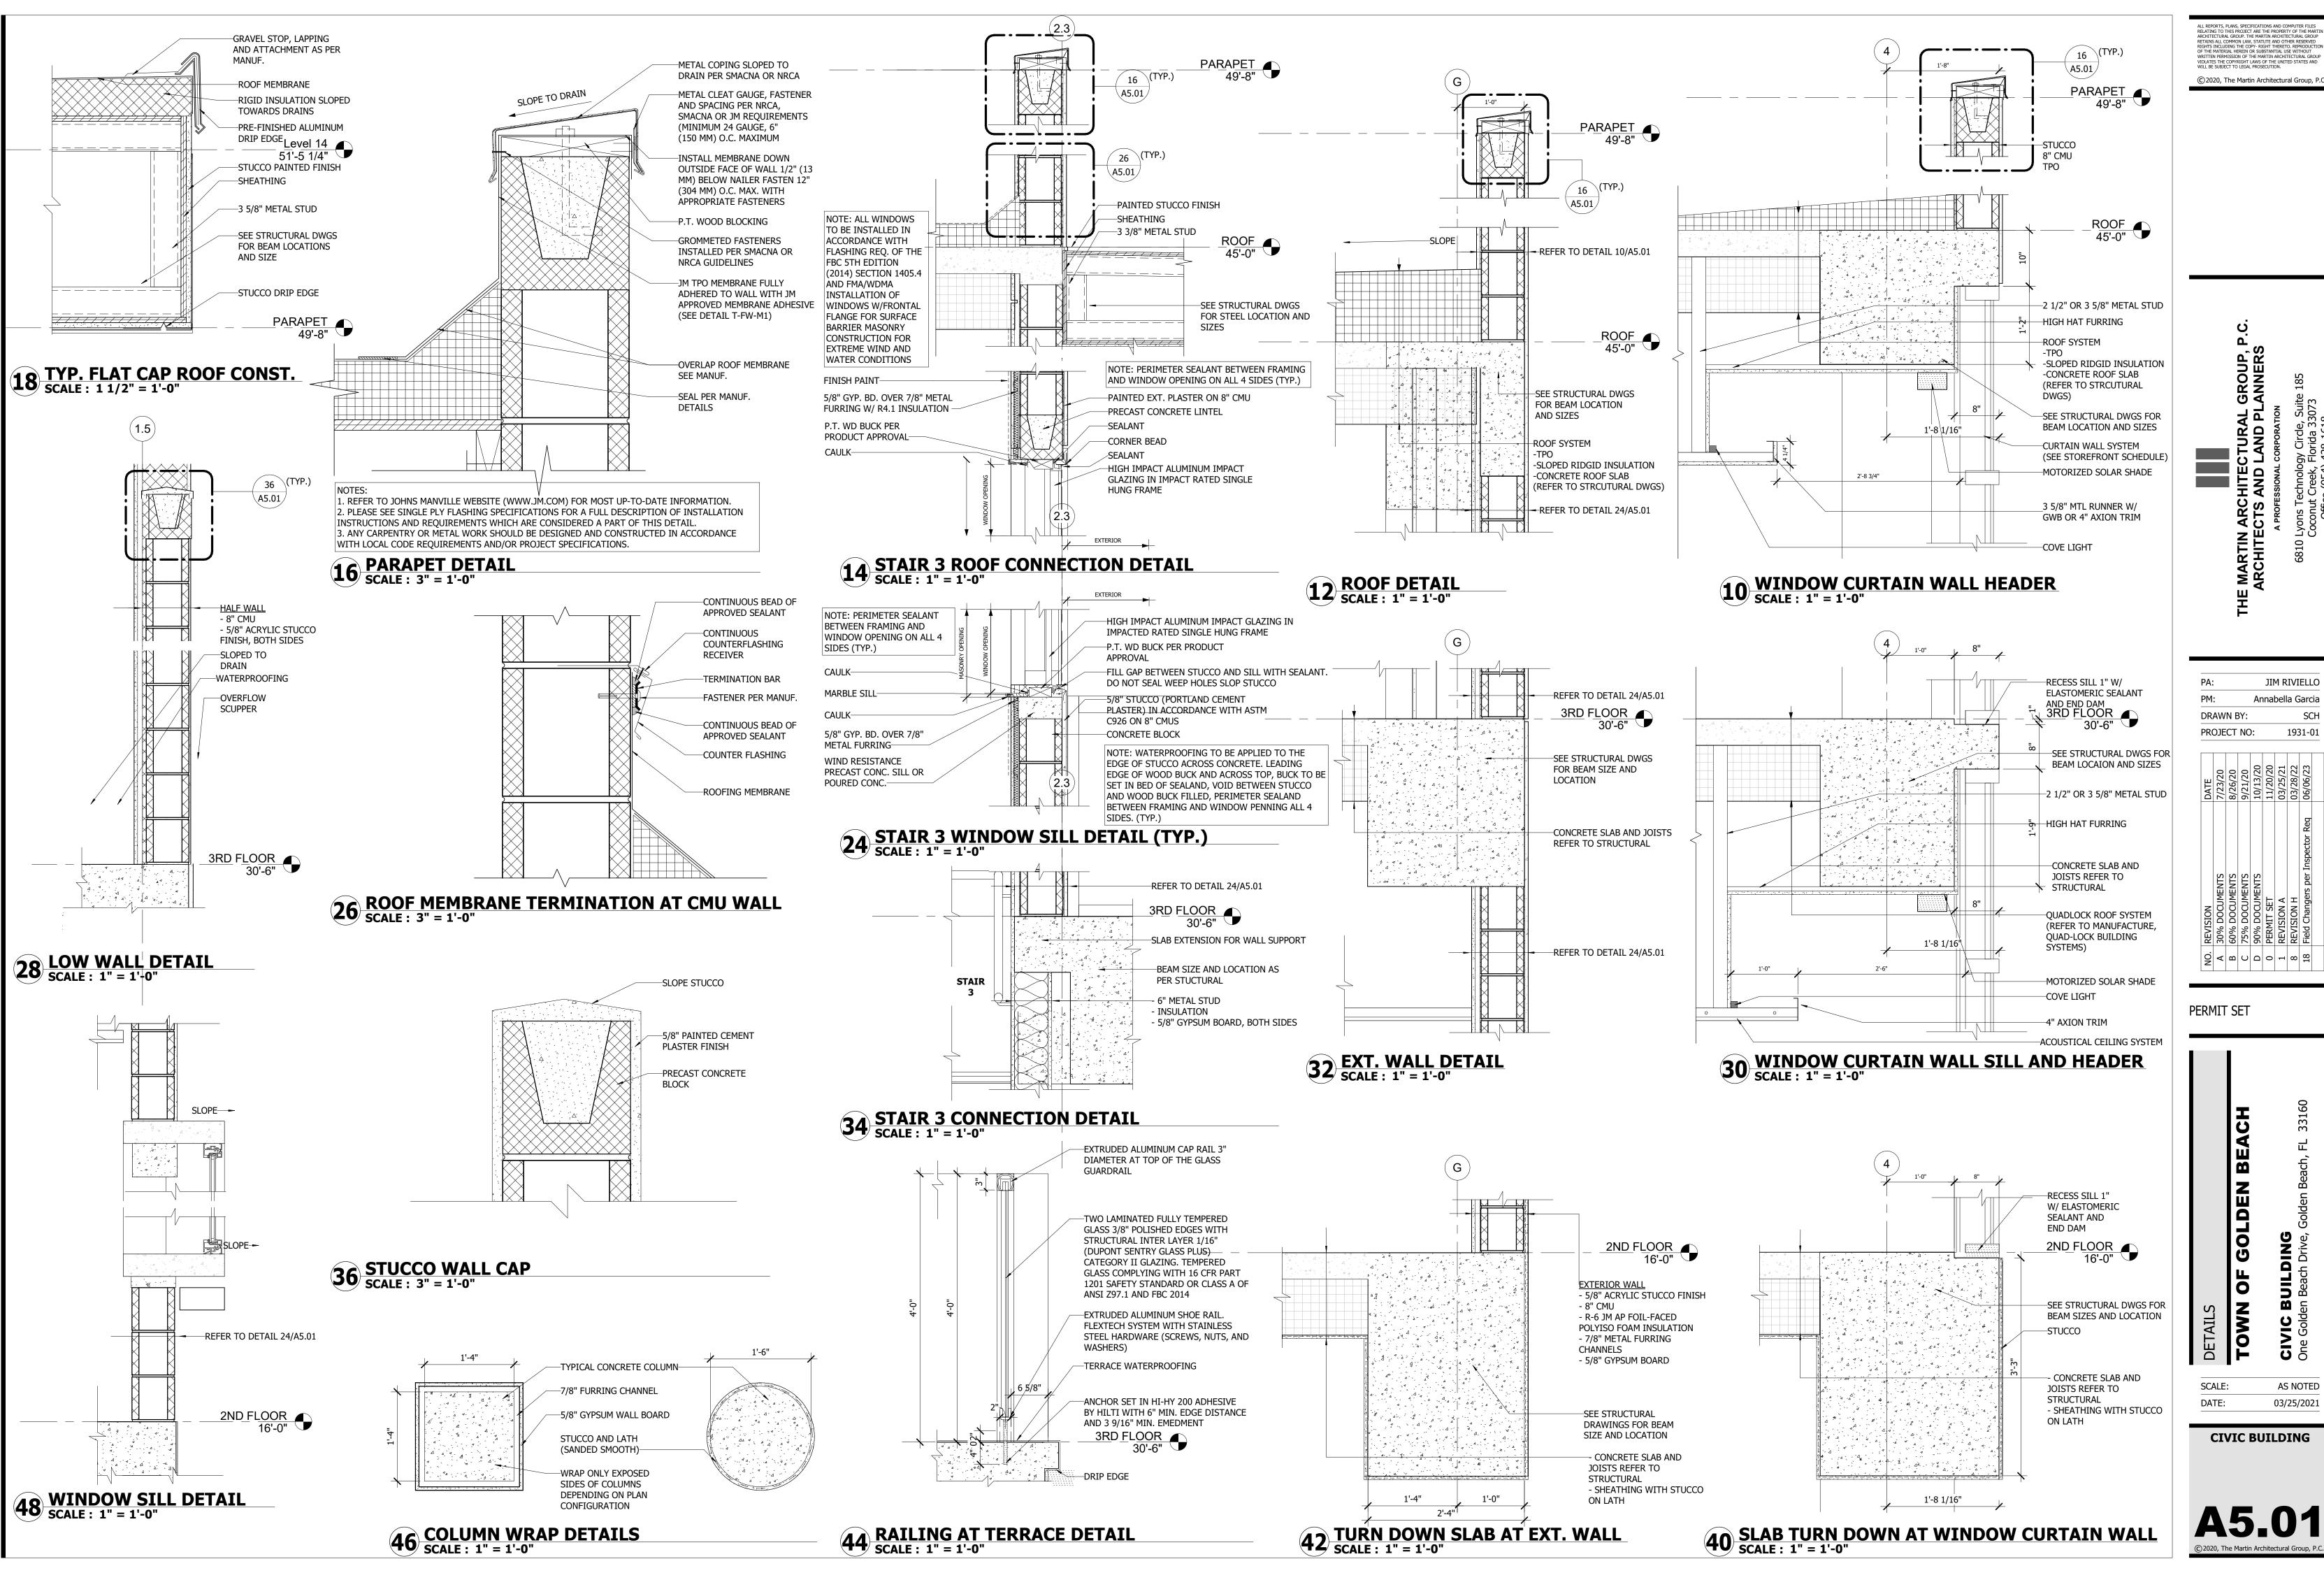


JIM RIVIELLO Annabella Garcia DRAWN BY: SCH PROJECT NO: 1931-01

PERMIT SET


GOLDEN OF


SCALE: AS NOTED 03/25/2021

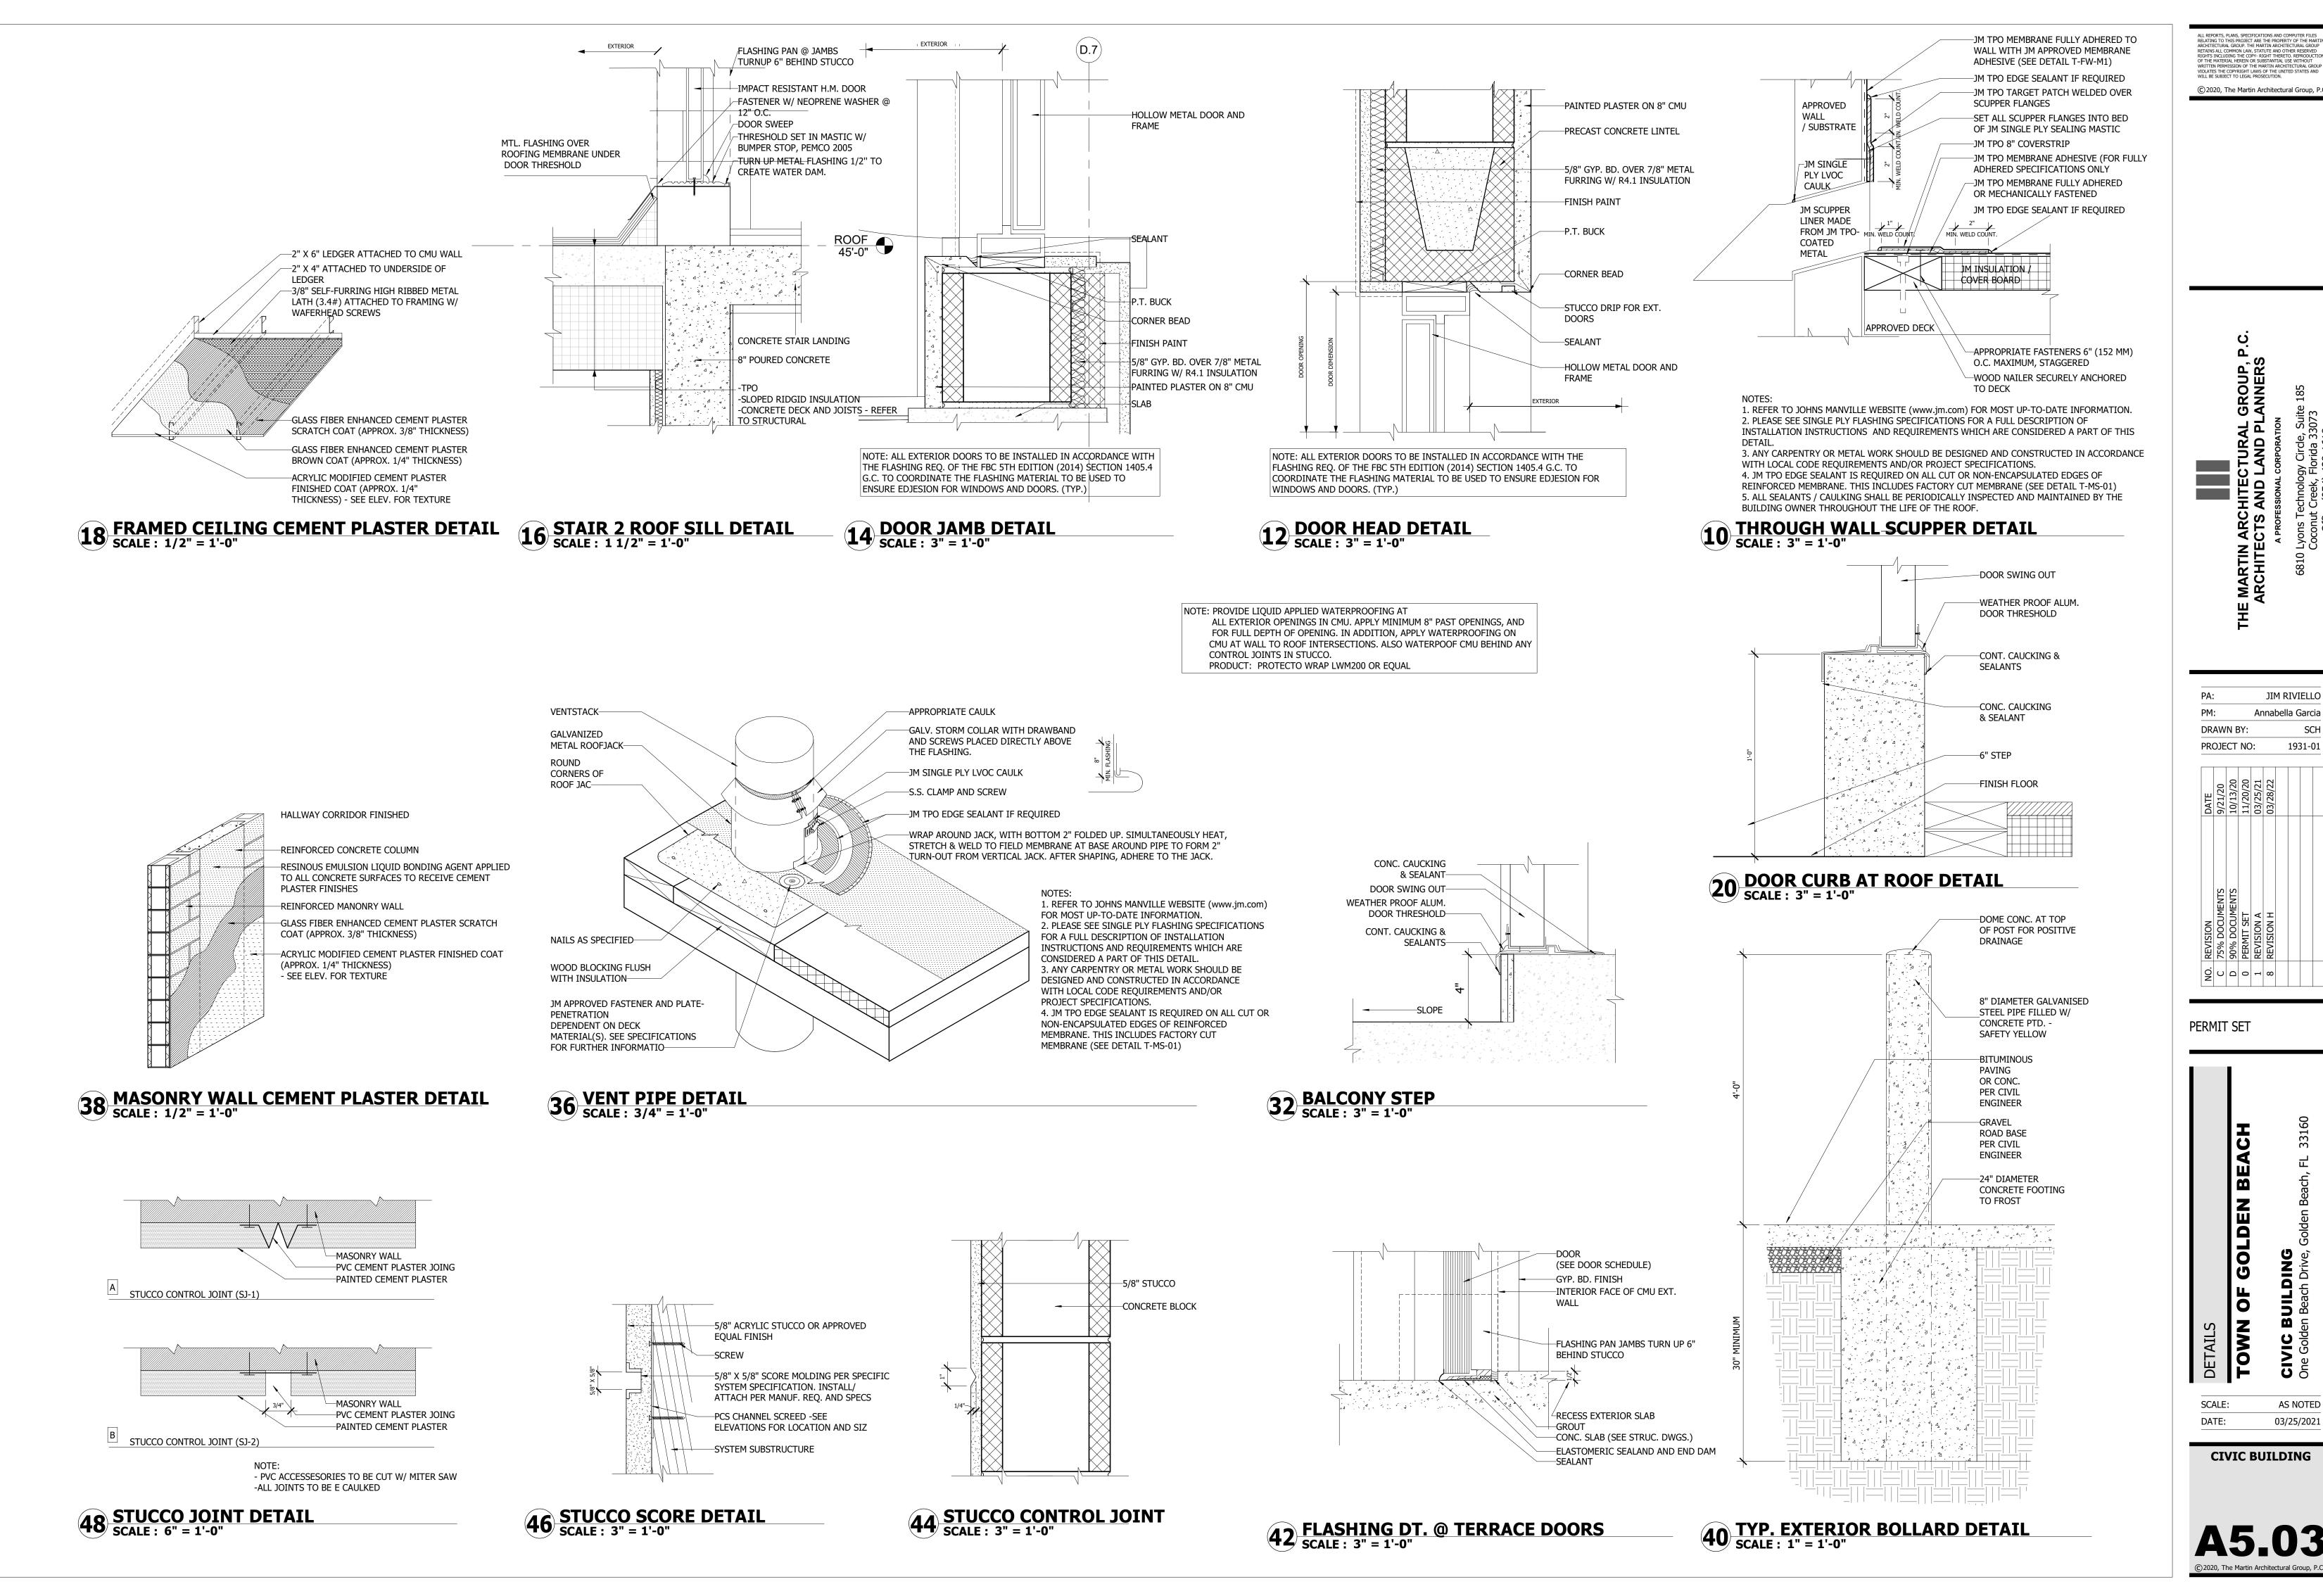

SCH

1931-01

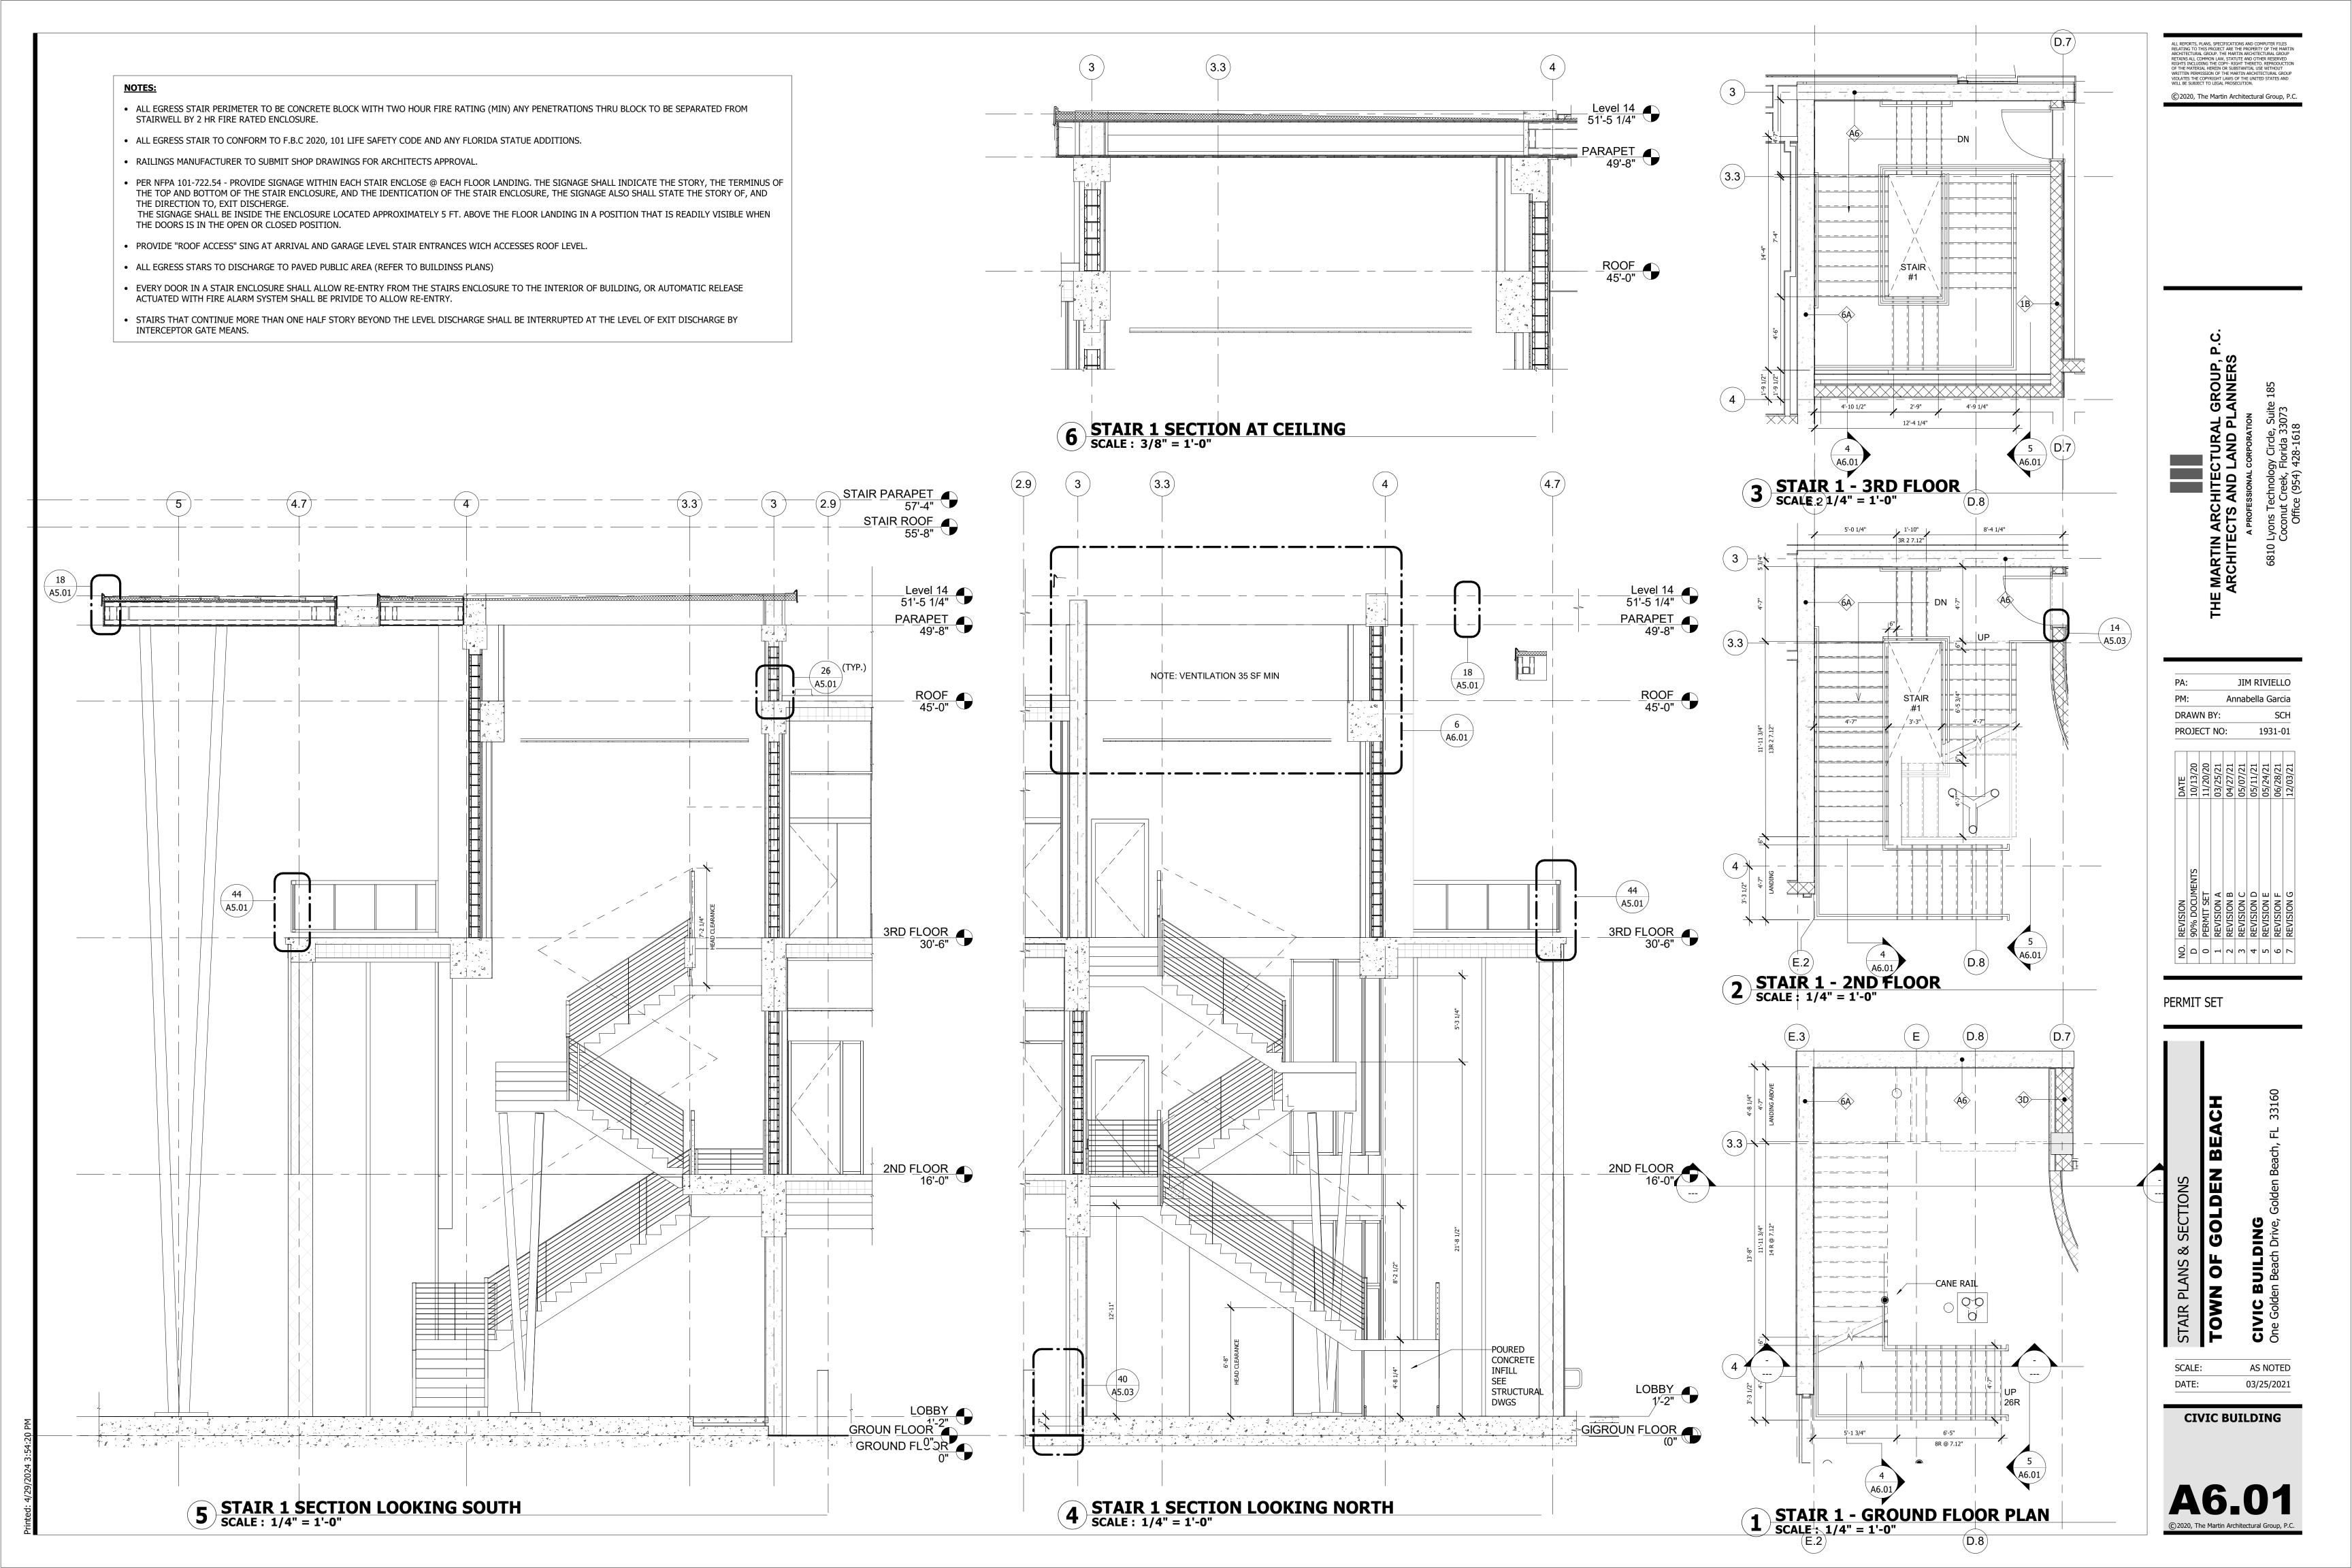

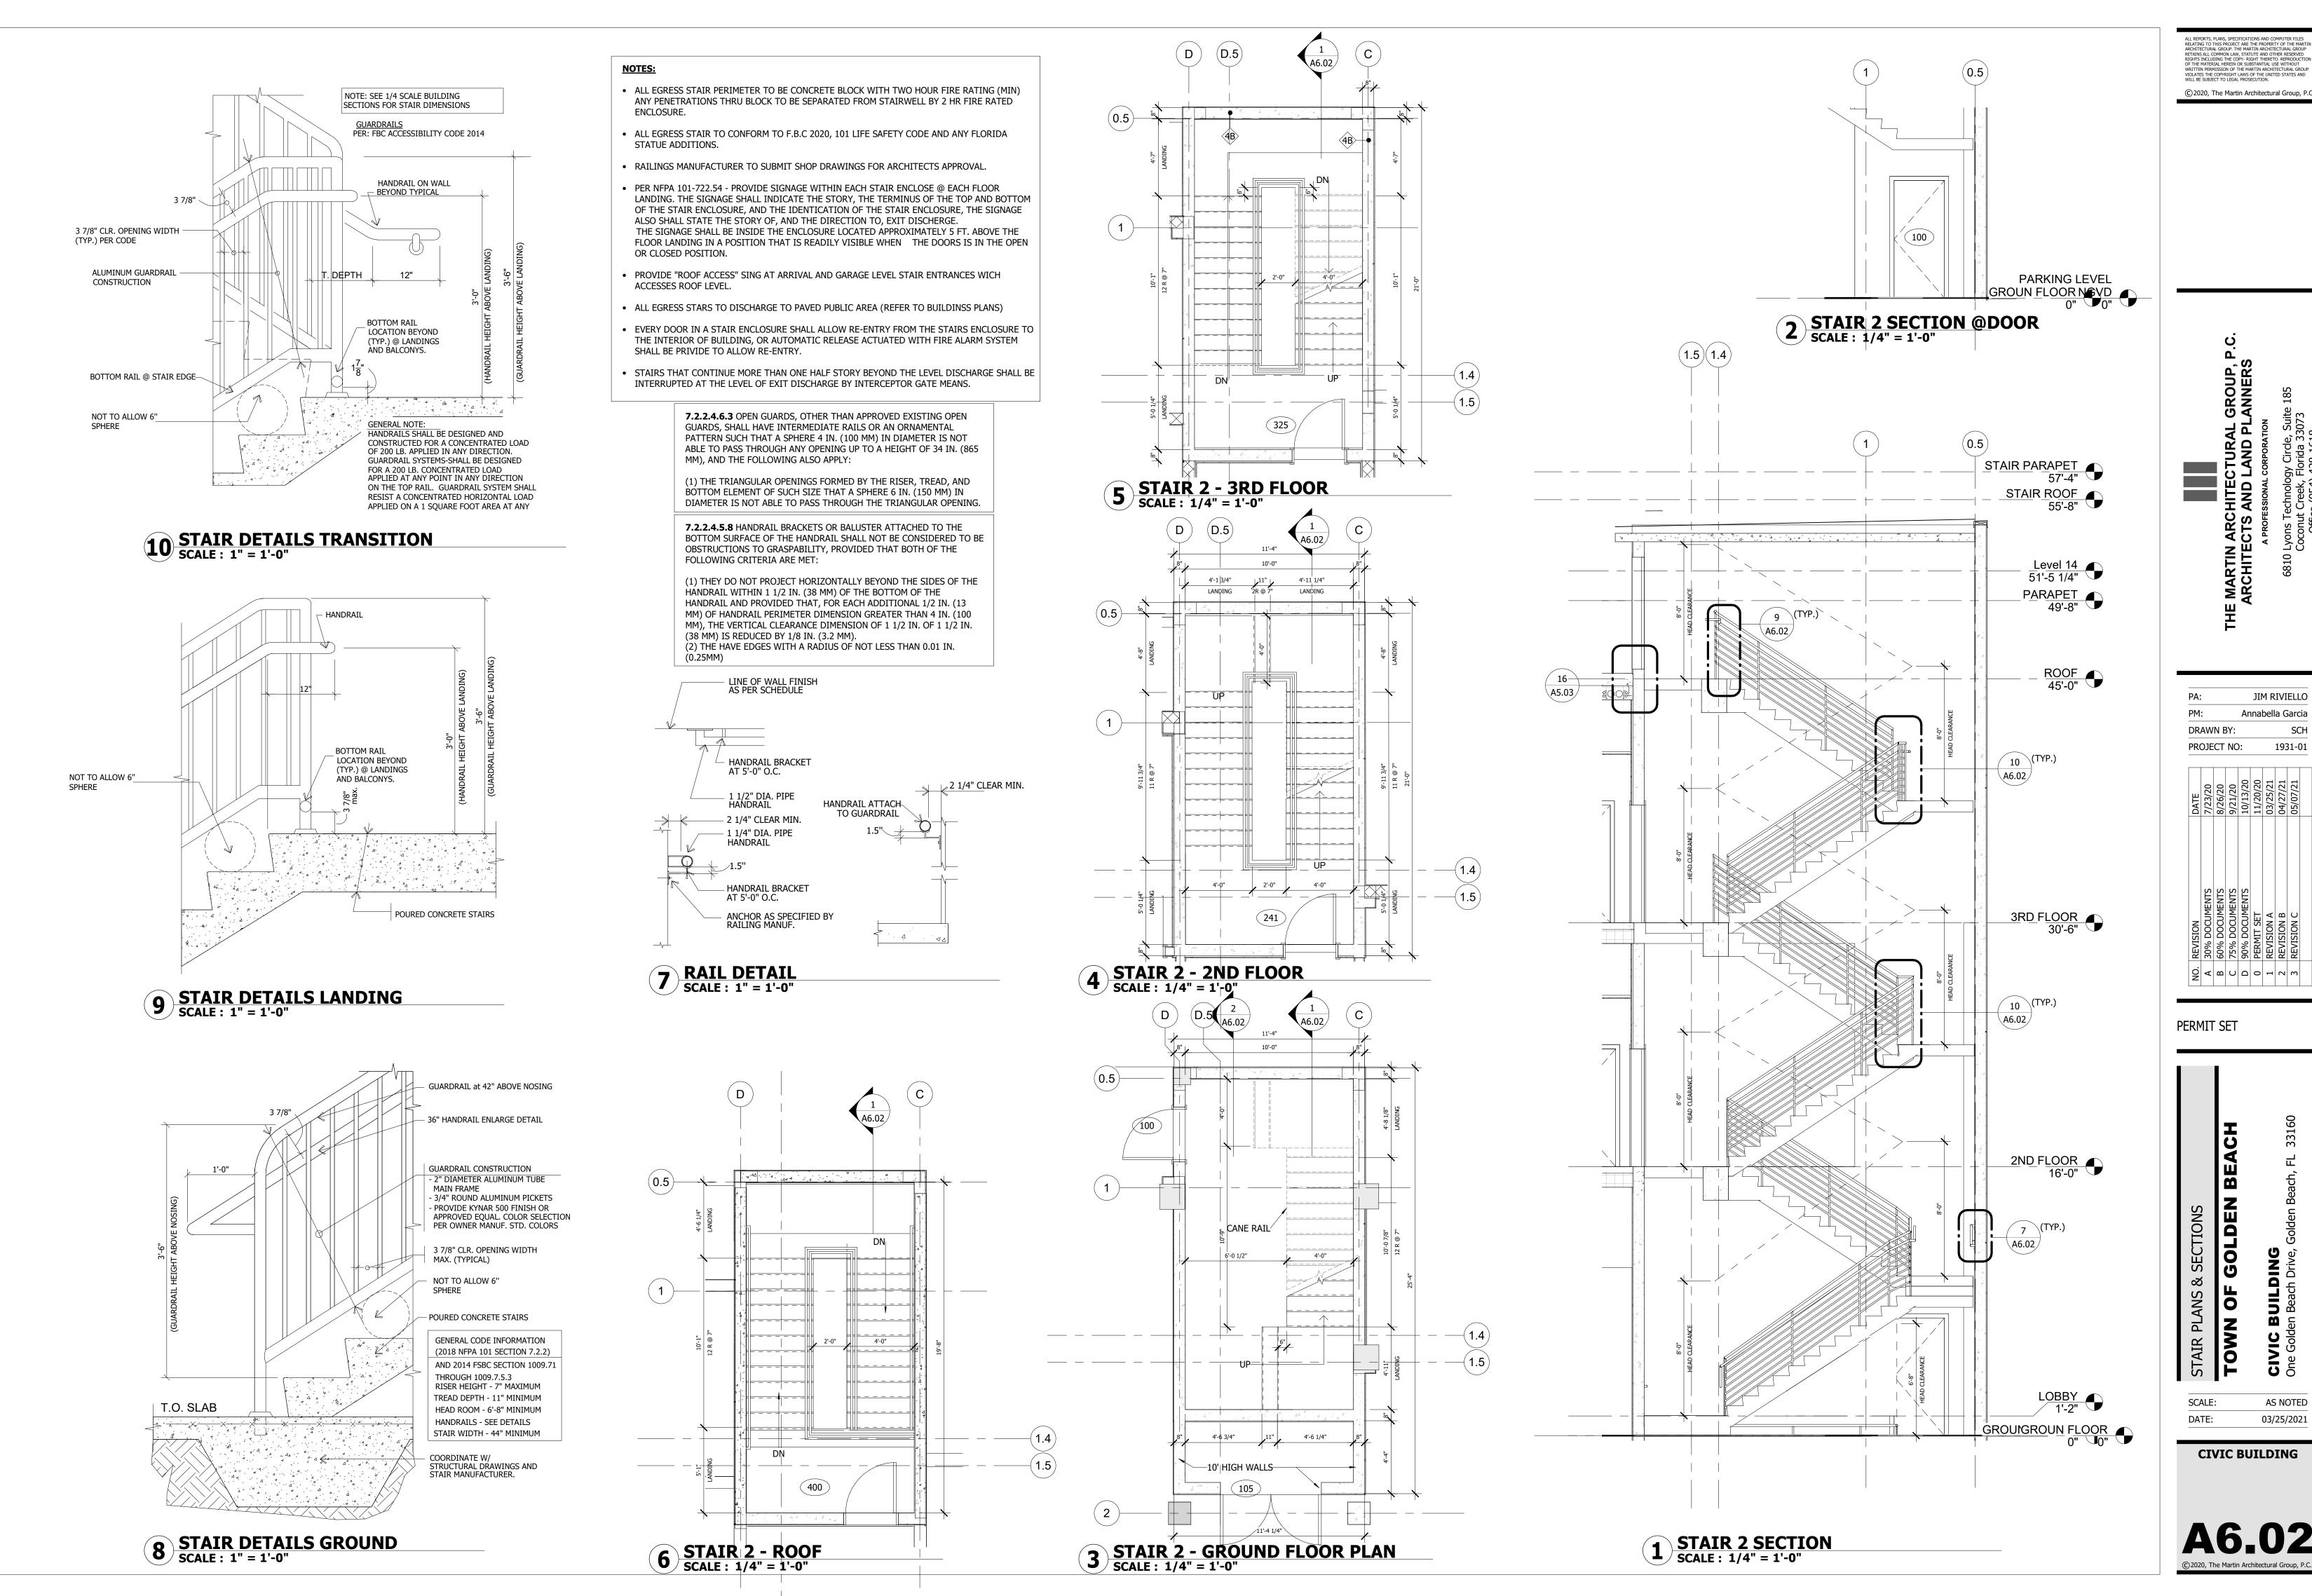


JIM RIVIELLO Annabella Garcia DRAWN BY: SCH 1931-01 PROJECT NO:


|3 | 2 | 1 | 0 | D | C | B | A | NO |


PERMIT SET

BEAC STAIR PLANS & SECTIONS
TOWN OF GOLDEN E

SCALE: AS NOTED 03/25/2021

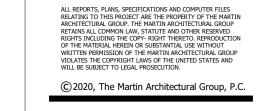

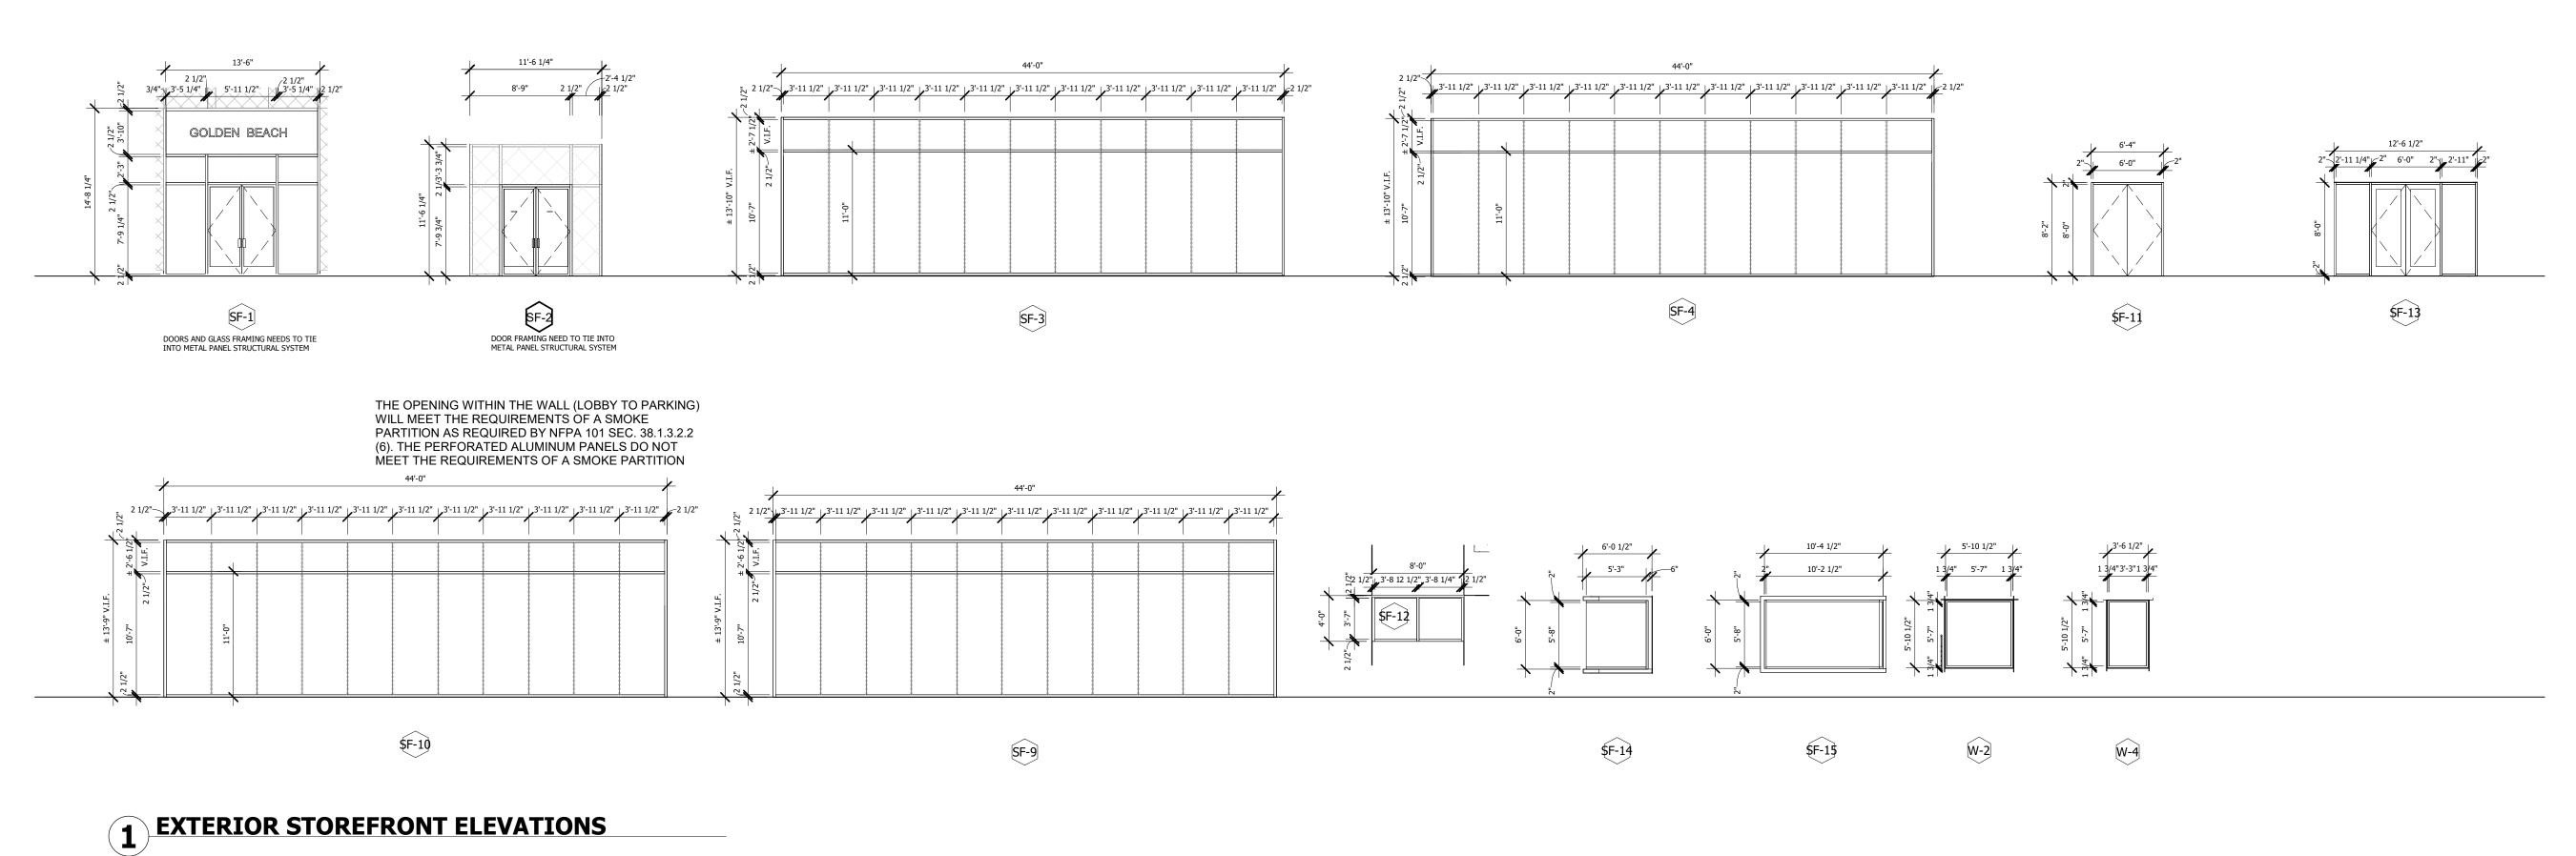

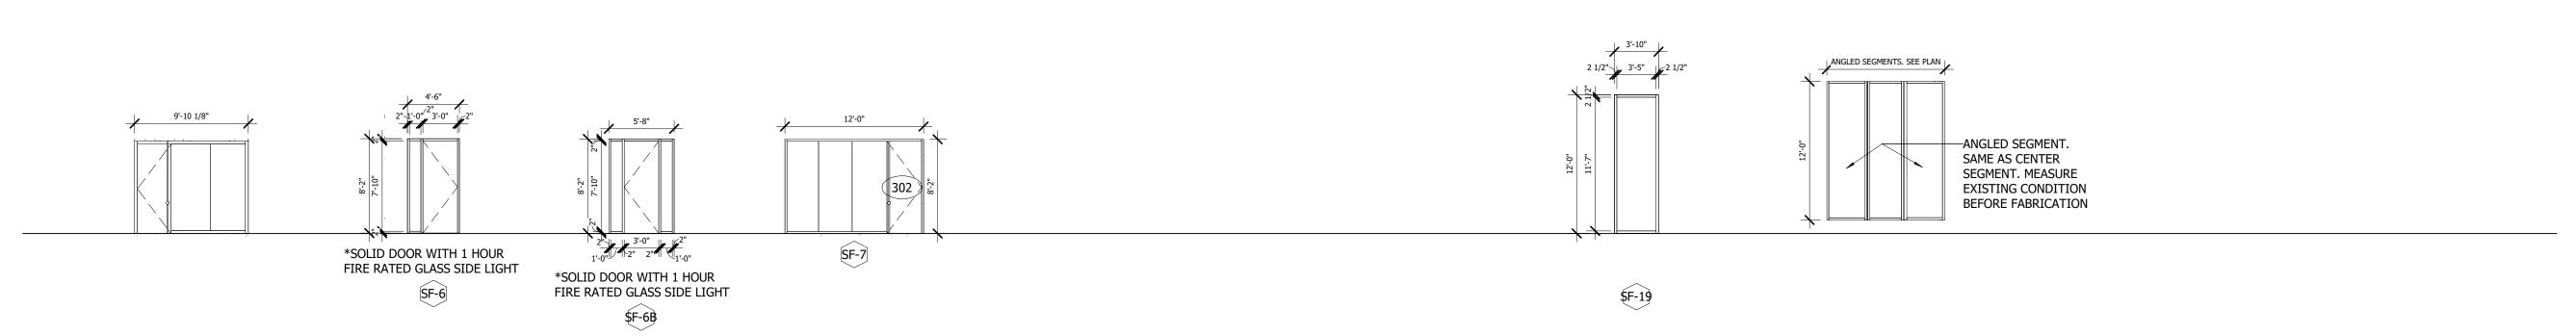

2 INTERIOR STOREFRONT ELEVATIONS
SCALE: 1/8" = 1'-0"

		STOREFRONT SCHEDULE	
Mark	Fire Rating	Manufacturer	Comments
SF-1			
SF-3		STEELBUILT CURTAINWALL INFINITY FRAME SYSTEM	REMOTE WINDOW SHADE/HI-IMPACT
SF-4		STEELBUILT CURTAINWALL INFINITY FRAME SYSTEM	REMOTE WINDOW SHADE/HI-IMPACT
SF-6			
SF-6B			
SF-7			
SF-8			
SF-9		STEELBUILT CURTAINWALL INFINITY FRAME SYSTEM	REMOTE WINDOW SHADE/HI-IMPACT
SF-10		STEELBUILT CURTAINWALL INFINITY FRAME SYSTEM	REMOTE WINDOW SHADE/HI-IMPACT
SF-11			HI-IMPACT
SF-12			HI-IMPACT
SF-13			
SF-14			
SF-15			HI-IMPACT
SF-19			
SF-19			
CE 21			

GENERAL NOTES:

ARCHITECT.

1. SEE SPECIFICATION SHEET FOR ADDITIONAL INFORMATION.

2. ALL GLAZING SHALL BE TEMPERED SAFETY GLAZING WHERE APPLICABLE PER LOCAL BUILDING CODE. 3. PROVIDE SAFETY GLAZING IN AN INDIVIDUAL FIXED OR OPERABLE PANEL ADJACENT TO A DOOR WHERE THE NEAREST EXPOSED EDGE OF GLAZING IS WITHIN A 24 INCH ARC OF EITHER A VERTICAL EDGE OF THE DOOR IN A CLOSED POSITION AND WHERE THE BOTTOM EXPOSED EDGE OF THE GLAZING IS LESS THAN 60 INCHES ABOVE THE WALKING SURFACE AS PER INTERNATIONAL BUILDING CODE (2009 EDITION) 2406.3. GLAZING IN ALL SWINGING AND SLIDING DOORS. 4. STOREFRONT FRAME COLOR TO BE DIRECTED BY


PM:	Annabella Garcia
DRAWN BY:	SCH
PROJECT N	O: 1931-01

9	NO. REVISION	DATE
0	PERMIT SET	11/20/20
1	REVISION A	03/25/21
2	REVISION B	04/27/21
3	REVISION C	05/07/21
8	REVISION H	03/28/22
11	REV J - Owner Changes Exec Rest	09/19/22
	Rm & Evidence	
15	REV M - Owner Changes	02/01/23
17	Clarifications @ Mimo Walls	03/07/23

PERMIT SET

STOREFRONT SCHEDULE
TOWN OF GOLDEN BEACH

SCALE: AS NOTED DATE: 03/25/2021

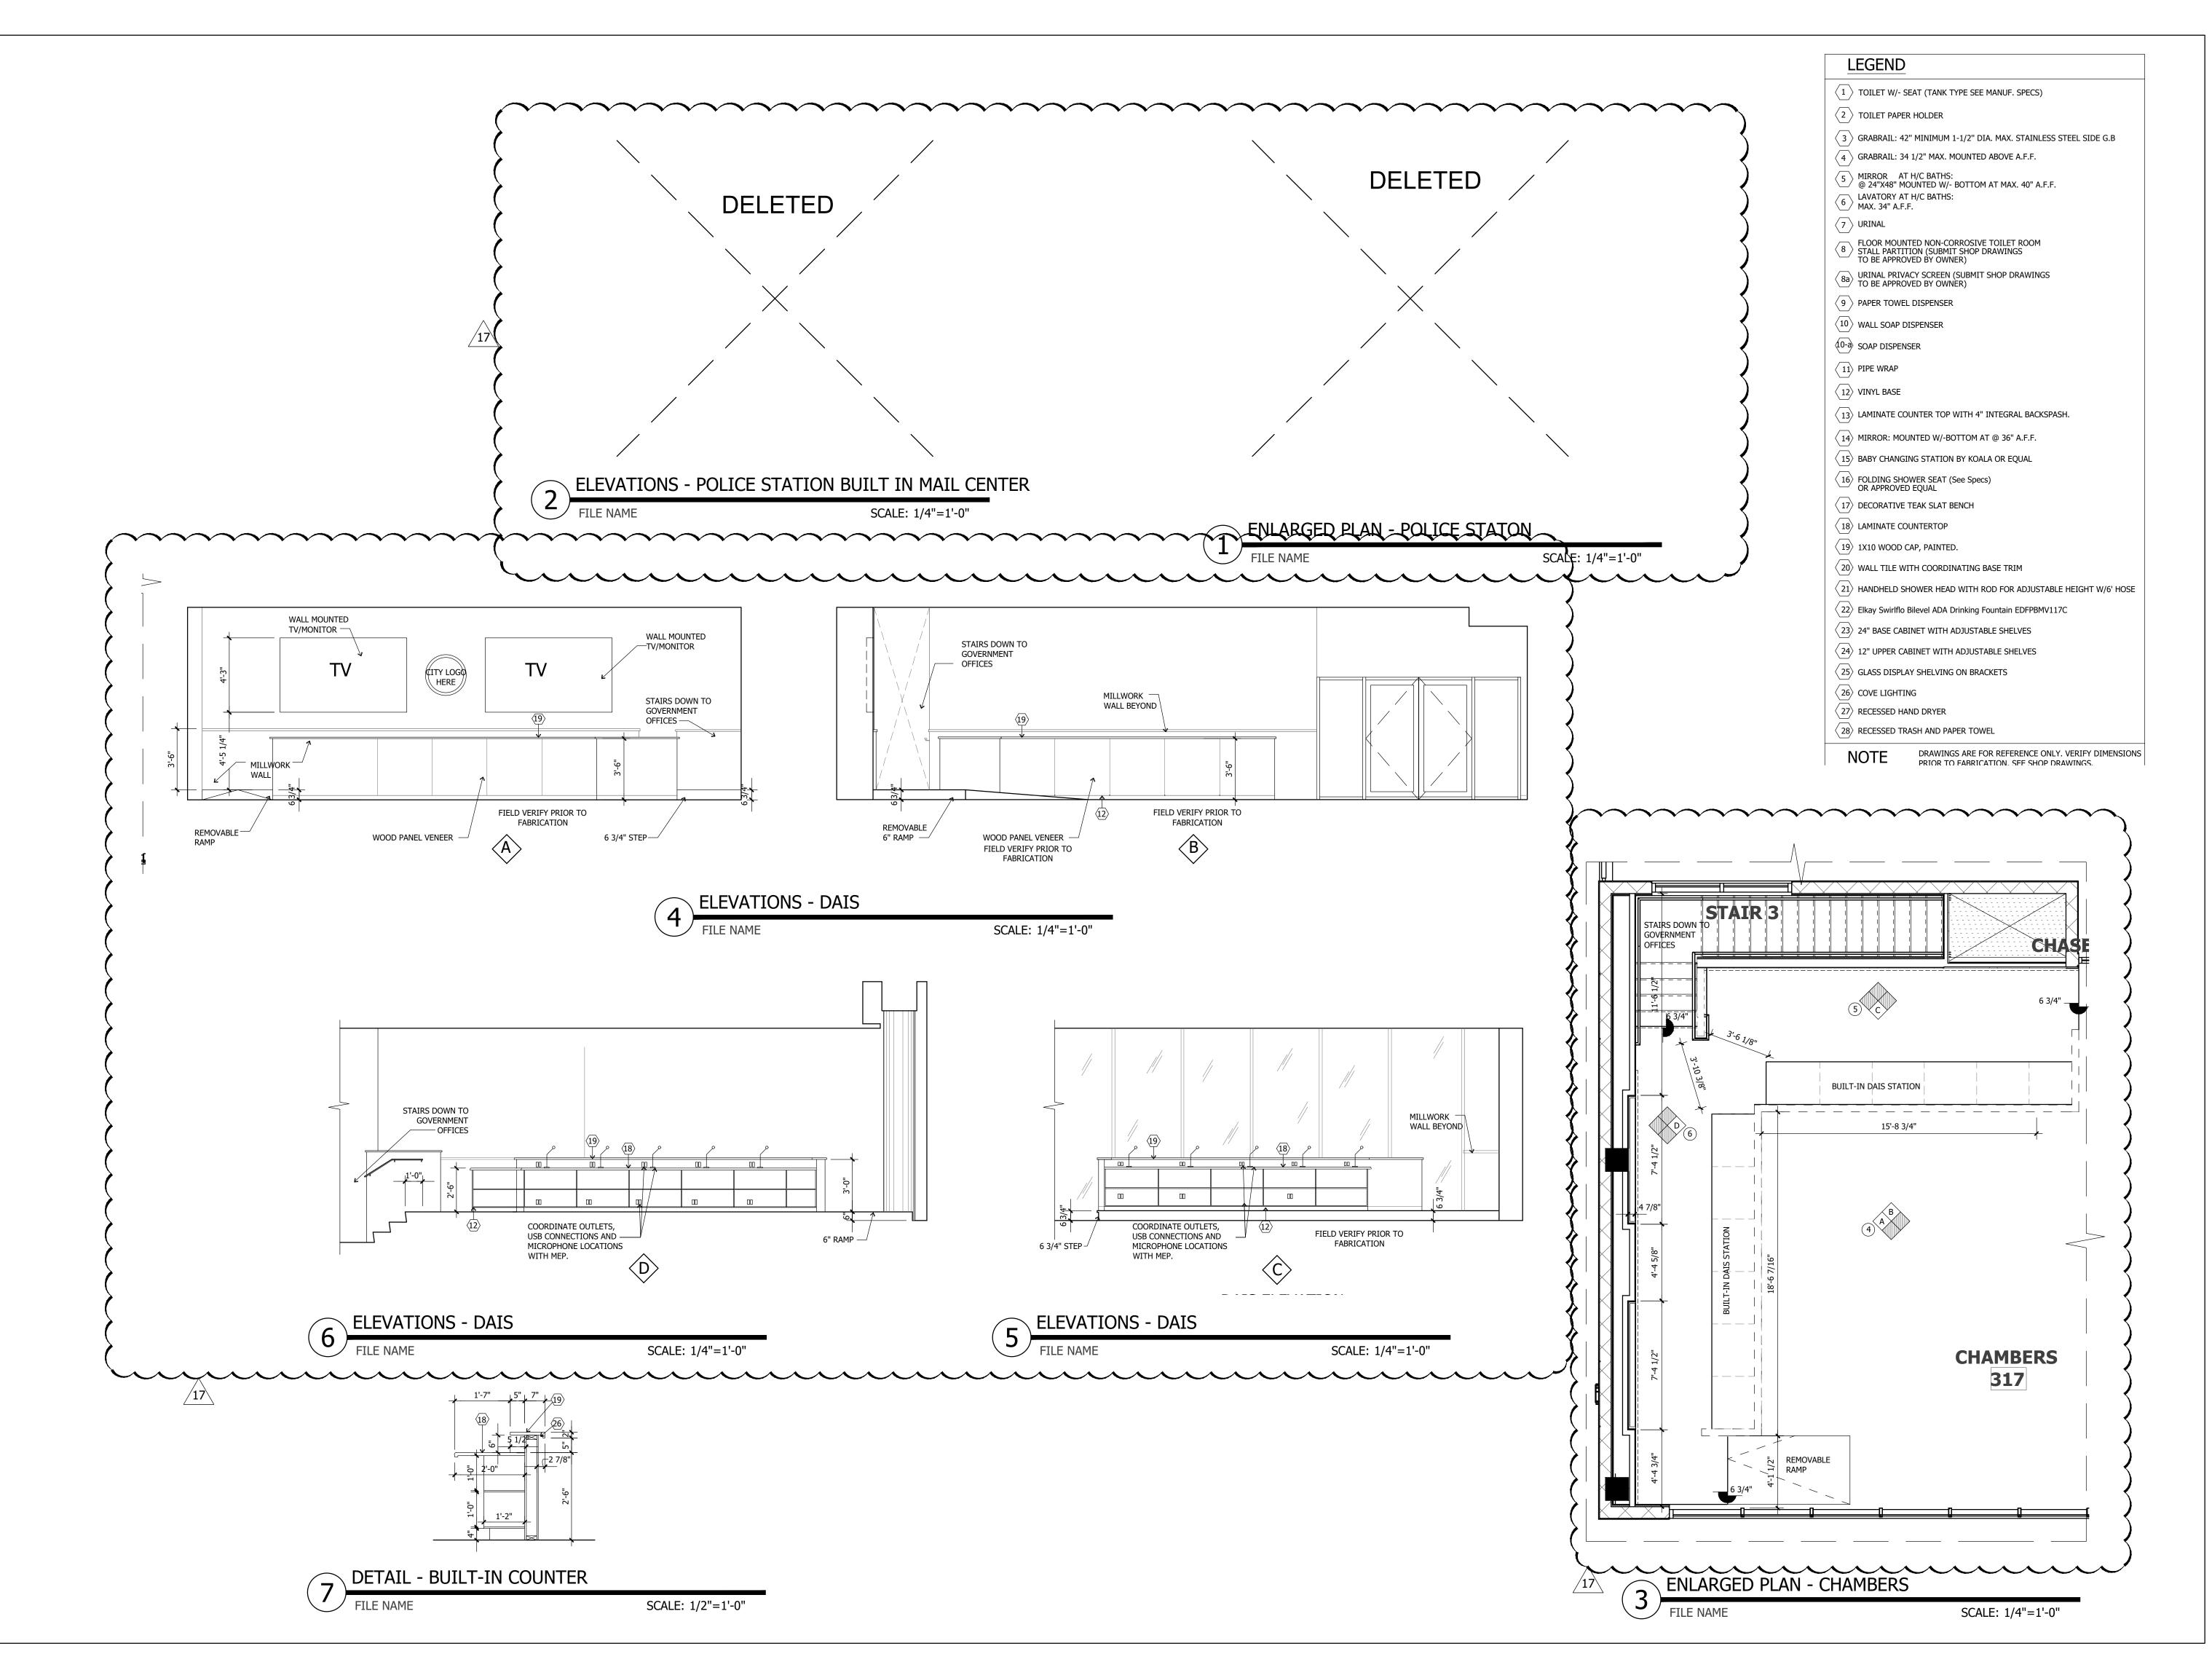

RELATING TO THIS PROJECT ARE THE PROPERTY OF THE MARTIN ARCHITECTURAL GROUP. THE MARTIN ARCHITECTURAL GROUP THE MARTIN ARCHITECTURAL GROUP SETAINS ALL COMMON LAW, STATUTE AND OTHER RESERVED RIGHTS INCLUDING THE COPY- RIGHT THERETO, REPRODUCTION OF THE MATERIAL HEREIN OR SUBSTANTAL USE WITHOUTON WRITTEN PERMISSION OF THE MARTIN ARCHITECTURAL GROUP VIOLATES THE COPYRIGHT LAWS OF THE UNITED STATES AND WILL BE SUBJECT TO LEGAL PROSECUTION.

WILL BE SUBJECT TO LEGAL PROSECUTION.

© 2021, The Martin Architectural Group, P.C.

TURAL GROUP, P.C. AND PLANNERS

ACHITECTS AND LAND PLA

A PROFESSIONAL CORPORATION

6810 Lyons Technology Circle, St

PA: DJR
PM: AG/JTD
DRAWN BY: SCH
PROJECT NO: 1931-01

 0
 PERMIT SET
 11/20/20

 8
 REVISION H
 03/25/22

 11
 REV J - OWNER CHANGES TO EXEC
 03/25/22

 12
 OWNER CHANGE LOUNGE AREA
 09/25/22

 13
 REV K - OWNER CHANGES BREAK
 12/21/22

 ROOM
 17
 OWNER FINISH CHANGES

 13
 OWNER CHANGES TO LOUNGE
 03/07/23

PERMIT SET

ELEVATIONS

DF GOLDEN BEACH

ILDING

TOWN OF GOLD

CALE: 8/26/2020

CIVIC BUILDING

A10.01